

# CITY OF TEMPE DEVELOPMENT REVIEW COMMISSION

Meeting Date: 05/14/2024

Agenda Item: 4


<u>ACTION</u>: Request for approval of a Development Plan Review consisting of a new 9,948 square foot warehouse and office building for **AME ELECTRICAL CONTRACTING OFFICE**, located at 1540 West Drake Drive. The applicant is Eric Leibsohn + Associates, Ltd.

**FISCAL IMPACT**: There is no fiscal impact on City funds.

**RECOMMENDATION:** Approve, subject to conditions

**BACKGROUND INFORMATION:** AME ELECTRICAL CONTRACTING OFFICE (PL240072) is proposing one new warehousing and office building on a currently vacant lot. The request includes the following:

DPR240028 Development Plan Review including site plan, building elevations, and landscape plan

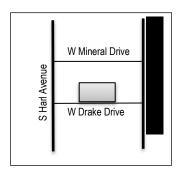

Property Owner
Applicant
Zoning District
Gross / Net site area
Total Building Area
Lot Coverage
Building Height
Building Setbacks

Landscape area Vehicle Parking Bicycle Parking Reinbold Development LLC

Eric Leibsohn, Eric Leibsohn + Associates, Ltd

General Industrial District (GID)

1.11 acres (48,323 s.f.) / 0.93 acres (40,513 s.f.)

9,948 s.f.

24.6% (No Standard)

30'4" (90' maximum allowed)

31'8" front, 70' west side, 78'1" east side, 33'6" rear

(25, 0, 0', 0' min.)

23.7% (10% minimum required)

33 spaces (29 min. required, 36 max allowed)

4 spaces (4 min. required)

**ATTACHMENTS:** Development Project File

**STAFF CONTACT(S):** Chris Jasper, Senior Planner (480) 350-8096

Department Director: Jeff Tamulevich, Community Development Director

Legal review by: N/A

Prepared by: Chris Jasper, Senior Planner Reviewed by: Michelle Dahlke, Principal Planner

#### **COMMENTS:**

This site is located on the north side of West Drake Drive, between South Priest Drive to the east and South Harl Avenue to the west. The site is surrounded by existing industrial uses to the north, south, east, and west, and is currently vacant.

This request includes the following:

1. Development Plan Review including site plan, building elevations, and landscape plan for a new two-story building totaling 9,948 square feet story building with proposed warehousing and office uses.

The applicant is requesting the Development Review Commission take action on the item above.

Staff has already approved an administrative Lot Combination to facilitate the development of the proposed project.

#### SITE PLAN REVIEW

This project went through the site plan review process a total of two (2) times, which consisted of one (1) preliminary review (01/17/2024) and one formal review (03/13/2024). A majority of the comments provided by staff were requests for additional information, corrections to errors, and minor design recommendations related to screen walls, landscaping, refuse enclosure and parking facilities. Staff also requested revisions to the proposed vehicular security gates, which resulted in modifications to the design from swinging gates to rolling gates to reduce conflicts with adjoining parking stalls. The applicant has incorporated all requested design recommendations into its plans.

#### **PUBLIC INPUT**

A neighborhood meeting was not required. Staff did not receive input from the public prior to the completion of this report.

#### PROJECT ANALYSIS

## **DEVELOPMENT PLAN REVIEW**

#### Site Plan

The subject site is approximately 0.93 net acres and is rectangular in shape. The proposed building is two stories, or approximately 30 feet, 4 inches in height, and will be approximately 9,948 square feet in area, most of which is proposed to be made up of warehousing space, and the remaining area will be utilized as office space. The building will be centrally located on the property and will be accessed via two driveways from Drake Drive that circulate delivery vehicles to the warehouse bay doors on the building's north side. The delivery area will be secured with two (2) sliding vehicular gates located on the east and west side of the building.

#### **Building Elevations**

The proposed building is primarily made up of masonry, with split-face CMU defining the base, middle, and top, broken up with horizontal bands of center-score block and smooth grey CMU blocks. The street-facing elevation features fenestration on the ground-floor level at the primary entry points, all of which are accentuated with overhanging metal shade canopies. Windows not otherwise covered by a shade canopy shall be installed with a stainless steel fin that surrounds the window and provides shade. The proposed colors, materials, and finishes are consistent and compatible with surrounding uses and structures.

## Landscape Plan

The proposed landscape coverage for this site is approximately 23.7%, which exceeds the minimum 10% required. The street frontage landscape area features "Red Push" Pistache and Sissoo trees, while Southern Live Oak and Fan West Ash trees are utilized in parking lot landscape islands and interior landscape areas. Additional shrubs and groundcovers utilized on the site include Orange Jubilee, Hopseed Bush, Dwarf Oleander, Cape Honeysuckle, Red Bird of Paradise, Whirling Butterflies, Mexican Honeysuckle, Thunder Cloud Sage, "Regal Mist" Deer Grass, Bush Morning Glory, Gold Mound Lantana, Dwarf Muhly, Ballerina Indian Hawthorn, and Dwarf Rosemary.

Section 6-306 D Approval criteria for Development Plan Review (in italics):

- 1. Placement, form, and articulation of buildings and structures provide variety in the streetscape; The proposed building is suitably set back from the street right of way and features a distinct form with horizontal movement along the ground-floor level and a variety of materials that break up the building façade.
- 2. Building design and orientation, together with landscape, combine to mitigate heat gain/retention while providing shade for energy conservation and human comfort; The proposed building includes numerous shade-providing structures and strategies, including shade canopies overhanging south-facing building entrances and unique steel "fins" that surround all single-pane windows and project out roughly 10 inches. Landscaping is utilized to provide substantial shade throughout the parking areas.
- 3. Materials are of a superior quality, providing detail appropriate with their location and function while complementing the surroundings; The proposed color and material palette primarily utilizes concrete with a wide variety of textures applied to break up the building façade. Concrete pop-outs along the west and east elevations serve to cast shadows and add depth to further break up the building façade. All of the proposed materials and finishes are consistent with and complementary of surrounding uses and structures.
- 4. Buildings, structures, and landscape elements are appropriately scaled, relative to the site and surroundings; The proposed building height is slightly more than 30 feet, which is appropriately scaled to the height of surrounding structures. The proposed landscaping is consistent with City requirements for street frontages and on-site landscaping, and it is also consistent with surrounding developments.
- 5. Large building masses are sufficiently articulated so as to relieve monotony and create a sense of movement, resulting in a well-defined base and top, featuring an enhanced pedestrian experience at and near street level; The proposed elevations feature several changes in plane and materials that result in the appearance of a well-defined building base and top.
- 6. Building facades provide architectural detail and interest overall with visibility at street level (in particular, special treatment of windows, entries and walkways with particular attention to proportionality, scale, materials, rhythm, etc.) while responding to varying climatic and contextual conditions; The façade features details and visual interest in a manner that is appropriate given the scale of the building and the surrounding context, and includes specific design elements to address climatic conditions.
- 7. Plans take into account pleasant and convenient access to multi-modal transportation options and support the potential for transit patronage; A pedestrian connection is provided from the public sidewalk to the primary building entrances, and bicycle parking is provided in accordance with City requirements.
- 8. Vehicular circulation is designed to minimize conflicts with pedestrian access and circulation, and with surrounding residential uses; Vehicular and pedestrian routes are separated and feature minimal on-site conflicts. Where pedestrian pathways intersect the development entry driveways, it is delineated with alternative hardscapes.
- 9. Plans appropriately integrate Crime Prevention Through Environmental Design principles such as territoriality, natural surveillance, access control, activity support, and maintenance; The project complies with all applicable CTPTED principles.
- 10. Landscape accents and provides delineation from parking, buildings, driveways and pathways; All landscaping adjacent to vehicular or pedestrian pathways are appropriate for the site context.
- 11. Signs have design, scale, proportion, location and color compatible with the design, colors, orientation and materials of the building or site on which they are located; Signs have been considered in the architectural form and will be addressed by a separate permit process and

12. Lighting is compatible with the proposed building(s) and adjoining buildings and uses, and does not create negative effects. All lighting must comply with current code requirements to meet minimum illumination levels and be non-intrusive to adjacent properties.

#### **REASONS FOR APPROVAL:**

- 1. The project will meet the development standards required under the Zoning and Development Code.
- 2. The proposed project meets the approval criteria for a Development Plan Review.

Based on the information provided and the above analysis, staff recommends approval of the Development Plan Review. This request meets the required criteria and will conform to the conditions.

**DEVELOPMENT PLAN REVIEW CONDITIONS OF APPROVAL: (Non-standard conditions are identified in bold)** EACH NUMBERED ITEM IS A CONDITION OF APPROVAL. THE DECISION-MAKING BODY MAY MODIFY, DELETE OR ADD TO THESE CONDITIONS.

#### General

- 1. Except as modified by conditions, development shall be in substantial conformance with the site plan and building elevations dated 03/31/2024 and landscape plan dated 12/30/2023. Minor modifications may be reviewed through the plan check process of construction documents; major modifications will require submittal of a Development Plan Review.
- 2. At the time a temporary construction fence is added to the site, a future development sign banner shall be attached to the fence and provide information for the new development, in conformance with the Zoning and Development Code, Section 4-903, Sign Type J. The sign banner shall include: project name/information and future tenant (if known). Images of the project may be included on the banner. A sign permit is required. The building permit plans shall include a note on the plans to provide this future development sign banner on site as long as the construction fencing remains.

## Site Plan

- 3. Provide service yard and mechanical (cooling tower/generator) yard walls that are at least 8'-0" tall as measured from adjacent grade or are at least the height of the equipment being enclosed, whichever is greater. Verify height of equipment and mounting base to ensure that wall height is adequate to fully screen the equipment.
- 4. Provide gates of steel vertical picket, steel mesh, steel panel or similar construction. Where a gate has a screen function and is completely opaque, provide vision portals for visual surveillance. Provide gates of height that match that of the adjacent enclosure walls. Review gate hardware with Building Safety and Fire staff and design gate to resolve lock and emergency ingress/egress features that may be required.
- 5. Provide upgraded paving at each driveway consisting of integral colored and scored concrete as identified on the site plan. Extend this paving in the driveway from the right-of-way line to 20'-0" on site and from curb to curb at the drive edges. From sidewalk to right-of-way line, extend concrete paving to match sidewalk.
- 6. Utility equipment boxes for this development shall be finished in a neutral color (subject to utility provider approval) that compliments the coloring of the buildings.
- 7. Place exterior, freestanding reduced pressure and double check backflow assemblies in pre-manufactured, pre-finished, lockable cages (one assembly per cage). If backflow prevention or similar device is for a 3" or greater water line, delete cage and provide a masonry or concrete screen wall following the requirements of Standard Detail T-214.
- 8. Relocate the bicycle parking pad outside of the required 20-foot parking setback and provide an accessible route from the proposed bicycle parking to the primary building entry.

#### Floor Plans

9. Provide visual surveillance by means of fire-rated glazing assemblies from stair towers into adjacent circulation spaces.

#### **Building Elevations**

10. The materials and colors are approved as presented:

Roof – Solid cap CMU block plus a bond beam block – Superlite – CMU Natural Grey

Primary Building - Split-faced CMU - Superlite - Keystone Grey SW 7504

Secondary Building – Center score block – Superlite – Portico SW 7548

Building Accent - Smooth regular block - Superlite - CMU Natural Grey

Pop-outs – 8" x 12" x 16" split faced SMU – Superlite – Keystone Grey SW 7504

Windows - Anodized aluminum frame - stainless steel plate around windows

Glazing – Low-E tinted tempered glass

Metal Canopy – Brush satin finish – City Scape SW 7067, glossy

Provide primary building colors and materials with a light reflectance value of 75 percent or less.

- 11. If provided, roof access shall be from the interior of the building. Do not expose roof access to public view.
- 12. Conceal roof drainage system within the interior of the building.
- 13. Exterior vents shall be architecturally integrated with the adjacent materials and matching colors specified on each elevation.
- 14. Incorporate lighting, address signs, and incidental equipment attachments (alarm klaxons, security cameras, etc.) where exposed into the design of the building elevations. Exposed conduit, piping, or related materials is not permitted.
- 15. Locate the electrical service entrance section (S.E.S.) inside the building or inside a secure yard that is concealed from public view.

## Lighting

- 16. This project shall follow requirements of ZDC Part 4, Chapter 8, Lighting, unless otherwise conditioned.
- 17. Illuminate building entrances and underside of open stair landings from dusk to dawn to assist with visual surveillance at these locations.

#### Landscape

- 18. Arterial street trees shall be a minimum of 36" box specimens and a minimum of 1 ½" caliper trunk.
- 19. Irrigation notes:
  - a. Provide pipe distribution system of buried rigid (polyvinylchloride), not flexible (polyethylene). Use of schedule 40 PVC mainline and class 315 PVC ½" feeder line is acceptable. Class 200 PVC feeder line may be used for sizes greater than ½". Provide details of water distribution system.
  - b. Locate valve controller in a vandal resistant housing.
  - c. Hardwire power source to controller (a receptacle connection is not allowed).
  - d. Controller valve wire conduit may be exposed if the controller remains in the mechanical yard.
- 20. Include requirement to de-compact soil in planting areas on site and in public right of way and remove construction debris from planting areas prior to landscape installation.
- 21. Top dress planting areas with a rock or decomposed granite application. Provide rock or decomposed granite of 2" uniform thickness. Provide pre-emergence weed control application and do not underlay rock or decomposed granite application with plastic.

22. Each landscape island shall be installed with a minimum of one (1) tree with a minimum caliper of one and one-half (1 ½) inches and five (5) ground covers of one (1) gallon size for each parking space length.

#### **Building Address**

- 23. Verify property address and submit a PDF copy of the site plan with unit floor plans for permanent addressing to <a href="mailto:permitcenter@tempe.gov">permitcenter@tempe.gov</a> prior to submittal of construction documents.
- 24. Provide address sign on the building elevation facing the street to which the property is identified.
  - a. Conform to the following for building address signs:
    - 1) Provide street number only, not the street name
    - 2) Compose of 12" high, individual mount, metal reverse pan channel characters.
    - 3) Self-illuminated or dedicated light source.
    - 4) On multi-story buildings, locate no higher than the second level.
    - 5) Coordinate address signs with trees, vines, or other landscaping, to avoid any potential visual obstruction.
    - 6) Do not affix numbers or letters to elevation that might be mistaken for the address.
  - b. Utility meters shall utilize a minimum 1" number height in accordance with the applicable electrical code and utility company standards.

## **CODE/ORDINANCE REQUIREMENTS:**

THE BULLETED ITEMS REFER TO EXISTING CODE OR ORDINANCES THAT PLANNING STAFF OBSERVES ARE PERTINENT TO THIS CASE. THE BULLET ITEMS ARE INCLUDED TO ALERT THE DESIGN TEAM AND ASSIST IN OBTAINING A BUILDING PERMIT AND ARE NOT AN EXHAUSTIVE LIST.

SITE PLAN REVIEW: Verify all comments by all departments on each Preliminary Site Plan Review. If questions arise related to specific comments, they should be directed to the appropriate department, and any necessary modifications coordinated with all concerned parties, prior to application for building permit. Construction Documents submitted to the Building Safety Division will be reviewed by planning staff to ensure consistency with this Design Review approval prior to issuance of building permits.

DEADLINE: Development plan approval shall be void if the development is not commenced or if an application for a building permit has not been submitted, whichever is applicable, within twelve (12) months after the approval is granted or within the time stipulated by the decision-making body. A complete building permit application shall be made on or before two (2) years from the date of city council approval or within a time stipulated as a condition of approval, when development plan review application is processed concurrently with a PAD Overlay District. The period of approval is extended upon the time review limitations set forth for building permit applications, pursuant to Tempe Building Safety Administrative Code, Section 8-104.15. An expiration of the building permit application will result in expiration of the development plan.

#### STANDARD DETAILS:

- Access to Tempe Supplement to the M.A.G. Uniform Standard Details and Specifications for Public Works
   Construction, at this link: <a href="https://www.tempe.gov/government/engineering-and-transportation/engineering/standards-details">https://www.tempe.gov/government/engineering-and-transportation/engineering/standards-details</a> or purchase book from the Public Works Engineering Division.
- Access to refuse enclosure details DS116 and DS118 and all other Development Services forms at this link: <a href="https://www.tempe.gov/government/community-development/building-safety/applications-forms">https://www.tempe.gov/government/community-development/building-safety/applications-forms</a>. The enclosure details are under Civil Engineering & Right of Way.

BASIS OF BUILDING HEIGHT: Measure height of buildings from top of curb at a point adjacent to the center of the front property line.

MECHANICAL SCREENING: All roof mounted mechanical equipment shall be concealed on all sides by elements that are an integral part of the building design and are equal to or greater in height than the mechanical equipment. Ground-mounted equipment may be screened using a masonry wall or other durable material as approved through development plan review.

WATER CONSERVATION AND EFFICIENCY: (Residential and parks are exempt, commercial and mixed use are not exempt). As required in <a href="Tempe City Code 33-140 - 142">Tempe City Code 33-140 - 142</a>, all new non-residential development projects are required to submit a Water Conservation Report that details potential water use, for review and approval by the Municipal Utilities Department, prior to building permit issuance. For a report template and more information, visit the <a href="commercial water conservation">commercial water conservation webpage</a>.

HISTORIC PRESERVATION: State and federal laws apply to the discovery of features or artifacts during site excavation (typically, the discovery of ancestral (human) remains or associated funerary objects). Arizona Revised Statutes § 41-865 stipulates that "any landowner with intention to disturb human remains or having unintentionally disturbed human remains shall immediately cease any activity in the vicinity of the remains and shall notify the Arizona State Museum Repatriation Office of the encounter. Any human remains and funerary objects shall not be further disturbed without obtaining written permission from the Repatriation Office." Additional information about requirements related to encountering and disturbing ancestral (human) remains and funerary objects on private land can be found on the Arizona State Museum website. While not required, applicants are encouraged to enlist the services of a qualified archaeological firm to conduct monitoring during ground-disturbing activity on private property that is Archaeologically Sensitive (AS). Contact the Historic Preservation Officer with general questions.

#### POLICE DEPARTMENT SECURITY REQUIREMENTS:

- Design building entrance(s) to maximize visual surveillance of vicinity. Limit height of walls or landscape materials, and design columns or corners to discourage ambush.
- Maintain distances of 20'-0" or greater between a pedestrian path of travel and any hidden area to allow for increased reaction time and safety.
- Follow the design guidelines listed under appendix A of the Zoning and Development Code. In particular, reference
  the CPTED principal listed under A-II Building Design Guidelines (C) as it relates to the location of pedestrian
  environments and places of concealment.
- Provide method of override access for Police Department (punch pad or similar) to controlled access areas.
- Refer to Tempe City Code Section 26-70 Security Plans.
- If the development includes a use listed in <a href="City Code Section 26-70(c">City Code Section 26-70(c</a>), the Owner is required to prepare a security plan with the Police Department. The architect should be involved to verify any modification that would require design revisions. To avoid revisions to permitted construction documents, initial meetings with the Police Department regarding the security plan are recommended before building permits are issued. At a minimum, the Owner shall contact the Police Department to begin security plan process approximately eight weeks prior to receipt of certificate of occupancy.
- Provide a security vision panel at service and exit doors (except to rarely accessed equipment rooms) with a 3" wide, high strength plastic or laminated glass window, located between 43" and 66" from the bottom edge of the door.

#### TRAFFIC ENGINEERING:

- Provide 8'-0" wide public sidewalk along arterial roadways, or as required by Traffic Engineering Design Criteria and Standard Details.
- Construct driveways in public right of way in conformance with Standard Detail T-320. Alternatively, the installation
  of driveways with return type curbs as indicated, similar to Standard Detail T-319, requires permission of Public
  Works, Traffic Engineering.
- Correctly indicate clear vision triangles at driveways on the site and landscape plans. Identify speed limits for adjacent streets at the site frontages. Begin sight triangle in driveways at point 15'-0" from face of curb. Consult Intersection Sight Distance memo, available from Traffic Engineering if needed <a href="https://www.tempe.gov/home/showpublisheddocument/6815/635323967996830000">https://www.tempe.gov/home/showpublisheddocument/6815/635323967996830000</a>. Do not locate site furnishings, screen walls or other visual obstructions over 2'-0" tall (except canopy trees are allowed) within each clear vision triangle.

#### FIRE:

• Clearly define the fire lanes. Ensure that there is at least a 20'-0" horizontal width, and a 14'-0" vertical clearance from the fire lane surface to the underside of tree canopies or overhead structures. Layout and details of fire lanes

- are subject to Fire Department approval.
- Provide a fire command room(s) on the ground floor of the building(s). Verify size and location with Fire Department.

## PRIVATE DEVELOPMENT ENGINEERING:

- An Encroachment Permit or License Agreement must be obtained from the City for any approved projections into the right of way or crossing of a public utility easement, prior to submittal of construction documents.
- An Encroachment Permit is required for any approved encroachment, temporary and removable in nature, that lies
  within, over or across any public Right of Way. A License Agreement will be required for any approved permanent
  structural encroachment into the Right of Way (roadway easements and PUE's are included by Tempe City Code
  definition).
- Permanent overhead structures will not be allowed above public water or sewer easements unless the vertical clearance is greater than 30 ft. per Engineering Design Criteria.
- All existing overhead utilities on or adjacent to site must be placed underground, including street crossings, per City
  of Tempe Code, Section 25-120 thru 25-126 & Ord # 88.85 except for transmission lines (greater than 12.5 kv).
- Coordinate site layout with utility provider(s) to provide adequate access easement(s). This is a private easement between the property owner and the utility company
- Clearly indicate right-of-way dimensions and property lines with dimensions, bearings and distances.
- Verify and show location of all easements, or property restrictions, to ensure no conflict exists with the site layout or foundation design. Provide recording number of existing easements. Any easements not dedicated to the city shall be labeled as private.
- 100-year onsite retention required for this property, coordinate design with requirements of the Engineering Department.

## SOLID WASTE SERVICES:

- Enclosure indicated on site plan is exclusively for refuse. Construct walls, pad and bollards in conformance with standard detail DS-116.
- Contact the Solid Waste Division to verify that vehicle maneuvering and access to the enclosure is adequate.
   Refuse staging and collection must be on site; no backing onto or off of streets, alleys or paths of circulation.
- Develop strategy for recycling collection and pick-up from site. Roll-outs may be allowed for recycled materials. Coordinate storage area for recycling containers with overall site and landscape layout.
- Gates for refuse enclosure(s) are not required unless visible from the street. If gates are provided, the property manager must arrange for gates to be open from 6:00 am to 4:30 pm on collection days.

## PARKING SPACES:

- Verify conformance of accessible vehicle parking to the Americans with Disabilities Act and the Code of Federal Regulations Implementing the Act. Refer to Building Safety ADA Accessible Parking Spaces Marking/Signage on Private Development details.
- At parking areas, provide demarcated accessible aisle for disabled parking.
- Distribute bike parking areas nearest to main entrance(s). Provide parking loop/rack per standard detail T-578.
   Provide 15" by 6'-0" individual bicycle parking spaces. One loop may be used to separate two bike parking spaces.
   Provide clearance between bike spaces and adjacent walkway to allow bike maneuvering in and out of space without interfering with pedestrians, landscape materials or vehicles nearby.

## ZONING AND DEVELOPMENT CODE:

Specific requirements of the Zoning and Development Code (ZDC) are not listed as a condition of approval but will apply to any application. To avoid unnecessary review time and reduce the potential for multiple plan check submittals, become familiar with the ZDC. Access the ZDC through <a href="www.tempe.gov/zoning">www.tempe.gov/zoning</a> or purchase from Community Development.

#### LIGHTING:

- Plans shall include the nearest adjacent street lights to the development. Street lights shall conform to the City of Tempe Public Works Standard Details and the Engineering Design Criteria Manual contained in the Comprehensive Transportation Plan
- Design site security lighting in accordance with requirements of ZDC Part 4 Chapter 8 (Lighting) and ZDC Appendix E (Photometric Plan).
- Indicate the location of all exterior light fixtures on the site, landscape and photometric plans. Avoid conflicts between lights and trees or other site features in order to maintain illumination levels for exterior lighting.

#### LANDSCAPE:

- Trees shall be planted a minimum of 16'-0" from any existing or proposed public utility lines. The tree planting separation requirements may be reduced to no less than 8'-0" from utility lines upon the installation of a linear root barrier. Per Detail T-460, the root barrier shall be a continuous material, a minimum of 0.08" thick, installed to a minimum depth of 4'-0" below grade. The root barrier shall extend 6'-0" on either side of the tree parallel to the utility line for a minimum length of 12'-0". Final approval is subject to determination by the Public Works, Water Utilities Division.
- Prepare an existing plant inventory for the site and adjacent street frontages. The inventory may be prepared by the Landscape Architect or a plant salvage specialist. Note original locations and species of native and "protected" trees and other plants on site. Move, preserve in place, or demolish native or "protected" trees and plants per State of Arizona Agricultural Department standards. File Notice of Intent to Clear Land with the Agricultural Department. Notice of Intent to Clear Land form is available at <a href="https://agriculture.az.gov/plantsproduce/native-plants">https://agriculture.az.gov/plantsproduce/native-plants</a>. Follow the link to "applications to move a native plant" to "notice of intent to clear land".

SIGNS: Separate plan review process is required for signs in accordance with requirements of ZDC Part 4 Chapter 9 (Signs). Refer to www.tempe.gov/signs.

DUST CONTROL: Any operation capable of generating dust, include, but not limited to, land clearing, earth moving, excavating, construction, demolition and other similar operations, that disturbs 0.10 acres (4,356 square feet) or more shall require a dust control permit from the Maricopa County Air Quality Department (MCAQD). Contact MCAQD at <a href="http://www.maricopa.gov/aq/">http://www.maricopa.gov/aq/</a>.

#### **HISTORY & FACTS:**

June 2, 1980 Subject site is platted as Lots 9 and 10 of the Lincoln – Elliot / I-10 subdivision.

March 27, 2024 Staff administratively approved a Lot Combination request to combine Lots 9 and 10 of the

Lincoln – Elliot / I-10 subdivision to facilitate the proposed development.

May 14, 2024 This request is scheduled to be heard by the Development Review Commission.

## **ZONING AND DEVELOPMENT CODE REFERENCE:**

Section 6-306, Development Plan Review



# **DEVELOPMENT PROJECT FILE**


# for AME ELECTRICAL CONTRACTING OFFICE (PL240072)

# **ATTACHMENTS:**

- 1-4. Site Context (Zoning Map, Aerial Map, Aerial with Site Plan Overlay, and Site Photos)
- 5-6. Applicant's Letter of Explanation
- 7-14. Site Design (Site Plan, Landscape Plan, Underground Utility and Lighting Plan, and Street Cross Sections)
- 15-31. Building Design (Blackline/Color Elevations, Sections, Renderings, Material Samples, and Floor Plans)
- 32. Supplemental Information
  - Turning Radius Exhibit

# Tempe. PL240072

# **AME ELECTRICAL CONTRACTING OFFICE**

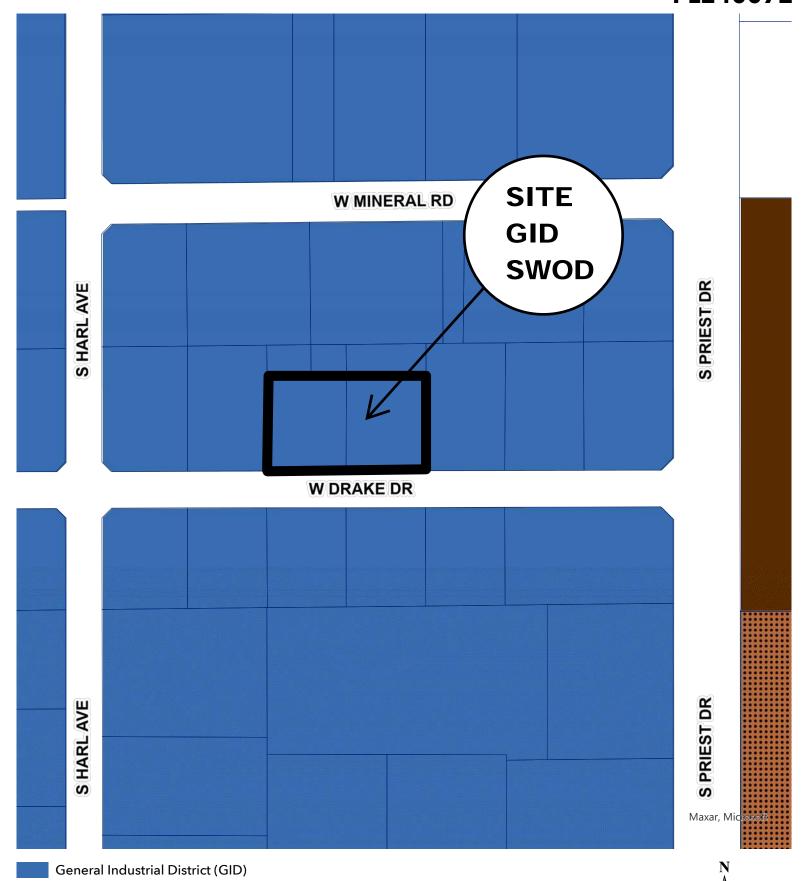



Multi-Family Residential Limited (R-3) Multi-Family Residential General (R-4)



# AME ELECTRICAL CONTRACTING OFFICE PL240072




**Aerial Map** 




# AME ELECTRICAL NEW BUILD

Two working days before you dig 263-1100 Mue State Center CALL COLLECT

1540 W. DRAKE DRIVE, TEMPE AZ 85283

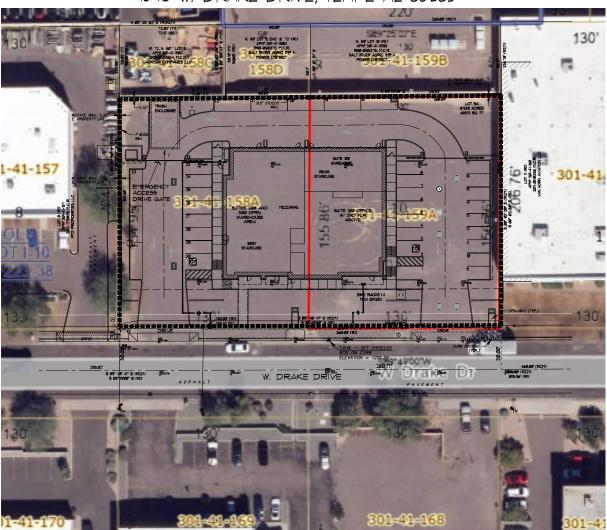

CONTEXTURAL AERIAL MAP & SITE PLAN OVERLAY

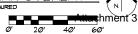

#### PROJECT DIRECTORY:

REINBOLD DEVELOPMENT, LLC 1120 S PRIEST DRIVE TEMPE AZ 85283 ANDY REINBOLD, PRESIDENT 602-437-7222 (OFFICE) andy@ameelectrical.com (EMAIL)

#### ARCHITECT:

ERIC LEIBSOHN 4 ASSOCIATES, LTD. 1910 N. RIDGEVIEW DRIVE PARADISE VALLEY, AZ 85253 ERIC LEIBSOHN, NCARB AZ REG ARCHITECT I5233 480-483-101 (OFFICE) eleibachnead con (FMAII.)

#### STRUCTURAL ENGINEER:

VERTEX CONSULTING STRUCTURAL ENGINEERS 8165 E. INDIAN BEND ROAD, SUITE 105 SCOTTSDALE, AZ 85250 CONTACT: SAM BURCHARD, P.E. 480-113-1042 (OFFICE) samevertexcse.com (EMAIL.

#### MECHANICAL, PLUMBING & ELECTRICAL ENGINEER:

ENERGY SYSTEM DESIGN, INC. 1135 E. CAMELBACK ROAD, UNIT 215 SCOTTSDALE, AZ 85251 CONTACT: DICK SANTISTEVAN 480-481-4972 (OFFICE) deantistevan@esdengineers.com (EMAIL)

#### CIVIL ENGINEER:

HUNTER ENGINEERING, INC. 10446 N. 14H STREET, SUITE 140 SCOTTSDALE, AZ. 85258 CONTACT: JEFF HUNTER, P.E. 480-991-3985 (PHONE) jeff@hunterengineeringpc.com

#### LANDSCAPE ARCHITECT:

BILTFORM LANDSCAPE ARCHITECT GROUP, INC. 11460 N. CAVE CREEK ROAD, SUITE 6 PHOENIX, AZ. 85020 CONTACT: DAVID FLYNN 602-285-9200 (OFFICE) dave@biltform.com (EMAIL)

#### SURVEYOR:

ALLIANCE LAND SURVEYING 19/00 N TOTAL AVENUE SHITE 10/4 GLENDALE, AZ, 853Ø3 CONTACT: RICHARD J GERMILLER JR. RLS. 623.972.2200, EXT 109 PHONE) richard@azals.com (EMAIL)

RENDER THIS DESIGN STUDIOS 9242 S. HEATHER DRIVE TEMPE, ARIZONA 85284 CONTACT: DAN MARTIN 602 908 4454 (PHONE) dmartin@renderthis.com

#### SEE SHEET A-01 FOR PROJECT DATA

## SHEET INDEX:

## ARCHITECTURAL:

COVER SHEET & CONTEXTURAL AERIAL/SITE PLAN OVERLAY SITE PLAN / PROJECT DATA & DIMENSIONS

A-02 SITE PLAN NOTES

A-Ø.3 CONTEXT PLAN 4 SITE PHOTOS A-0.4 SITE PLAN / VARIOUS TURNING RADIUS

EMERGENCY ACCESS SLIDING GATE WEST A-0.5 EMERGENCY ACCESS SLIDING GATE EAST A-0.6

A-0.7 SITE DETAILS A-0.8 SITE DETAILS

A-1.0 OVERALL 16T FLOOR PLAN A-LI OVERALL 2ND FLOOR PLAN

A-1.2 ENLARGED IST FLOOR OFFICE PLAN ENLARGED IST FLOOR OFFICE DIMENSIONED

A-2.0 ELEVATIONS (BLACKLINE) A-2.1 ELEVATIONS (BLACKLINE)

ELEVATIONS (COLOR) ELEVATIONS (COLOR) A-2.3 3D RENDERING PERSPECTIVE A-2.4

A-2.5 3D RENDERING PERSPECTIVE DIGITAL MATERIAL FINISHES A-3.0

A-4.0 A-4.1 SECTIONS

ENLARGED WALL SECTIONS Δ-42

ENLARGED WALL SECTIONS

ELECTRICAL SITE PLAN ELECTRICAL PHOTOMETRY PLAN F12 El3 EXTERIOR LIGHT FIXTURES

#### CIVIL:

CONCEPTUAL PLAN COVER SHEET CONCEPTUAL GRADING AND DRAINAGE СЗ

TYPICAL SECTIONS

#### LANDSCAPE:

PLI.I PRELIMINARY LANDSCAPE PLAN

#### SURVEYOR.

SHEET I OF 2 REPLAT COVER SHEET SHEET 2 OF 2



#### REFERENCE DOCUMENTS

(R) DEED 2023-0580941, M.C.R. (RI) PLAT PER BOOK 223, PAGE 38, M.C.R. (R2) R.O.S. PER BOOK 1019, PAGE 39, M.C.R. (R3) R.O.S. PER BOOK 1503, PAGE 35, M.C.R

#### LEGAL DESCRIPTION:

REPLAT TO COMBINE LOTS 9 AND 10. "LINCOLN-ELLIOT" / I-10, BOOK 22 OF MAPS, PAGE 38, MARICOPA COUNTY RECORDS, LOCATED IN THE SOUTHEAST QUARTER OF SECTION 8, TOWNSHIP I SOUTH, RANGE 4 EAST OF THE GILA AND SALT RIVER BASE AND MERIDIAN, MARICOPA COUNTY, ARIZONA

CITY OF TEMPE APPROVAL:





TEMPE PRELIMINARY CASE® SPR24006

.

ပ Ē

> DIRECT ₽ N N N

BUILDING

¥ ₩

ELECTRICAL DRAKE DRIVE 3, AZ 85283 SHEET/SHEET IN AME ELI 1540 W. D TEMPE, A

DATE 196UED: #3/31/2#2-

HECKED BY: EL4


SHEET NUMBER

1 OF 24




CONTEXT PLAN - APN# 301-41-158A \$ 301-41-1594

(FOR REFERENCE ONLY)

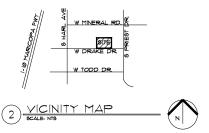





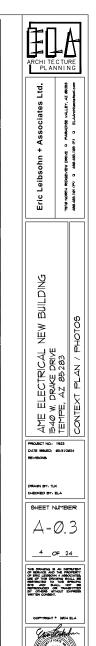

EXPIRES 06/30/2021

APRIL 25, 2024

# LETTER OF EXPLANATION

RE:

AME ELECTRICAL CONTRACTING NEW BUILDING

1540 W. DRAKE DRIVE

SPR 24005

EXISTING VACANT PARCEL LOCATED AT 1540 W. DRAKE DRIVE (PARCEL NUMBERS 301-41-159A AND 301-41-158A). THIS PARCEL WILL BE FOR THE DEVELOPMENT OF A NEW OFFICE WAREHOUSE BUILDING WITH A FOOTPRINT OF 9948 SF. THE SECOND FLOOR WILL BE STORAGE CONSISTING OF 3429 SF.

SUITE #100 WILL BE OCCUPIED BY THE BUILDING OWNER (REINBOLD DEVELOPMENT, LLC / AME ELECTRICAL CONTRACTING) AND WILL BE BUILT OUT FOR A TI. SUITES # 200 + 300 WILL BE BUILT OUT AS OPEN TI FOR STORGE OF PERSONAL ITEMS OF THE BUILDING OWNER ANDY REINBOLD (SEE ATTACHED BUILDING AREA MATRIX FOR MORE DETAIL INFORMATION).

THE EXISTING AND PROPOSED ZONING OF THE PROPERTY IS GID – GENERAL INDUSTRIAL DISTRICT WITH SOUTHWEST OVERLAY DISTRICT. THE DESIGN OF THE BUILDING AND SITE WILL SATISFY ALL APPLICABLE ZONING AND BUILDING CODES AS REQUIRED.

SUBMITTED BY:


ERIC LEIBSOHN, NCARB

Eine Cerbsoh

AZ REGISTERED ARCHITECT 15233

				BUILD	BUILDING AREA	<b>す</b>			
		OFFICE	<u>C</u> E	SUITE 100 2ND FLR STORAGE	FLR STORAGE	IST FLOOR	1ST FLOOR WAREHOUSE	GR088	T T T T T T T T T T T T T T T T T T T
	occup:	B (BUSINESS)	INESS)	8 (STORAGE)	RAGE)	S (STORAGE)	(STORAGE)	<u> </u>	5
Attac		GROSS SF	NET SF	GROSS SF	NET SF	GROSS SF	NET SF	\	
hme	SUITE 100	* 3,166 SF	3,092 5F	* 3,429 SF	3,065 5F	1,729 SF	1,644 SF	8,324 SF	7,8∅1 5F
nt 6	SUITE 200 ≰ 300 (WHOLE)			149 SF (MEZZANINE)	138 SF (MEZZANINE)	4,727 SF	4,558 SF	4,876 SF	4,696 SF
	SES/FIRE					87 SF		₽2 TS	
	TOTALS	3,166 5F	3,092 5F	3,578 9F	3,2∅3 5F	6,543 SF	6,2Ø2 SF	13,287 5₽	12,497 SF
	BUILDING FOOTPRINT	5						9,948 SF	3 SF

\* INCLUDES 1/2 OF BOTH STAIRCASES

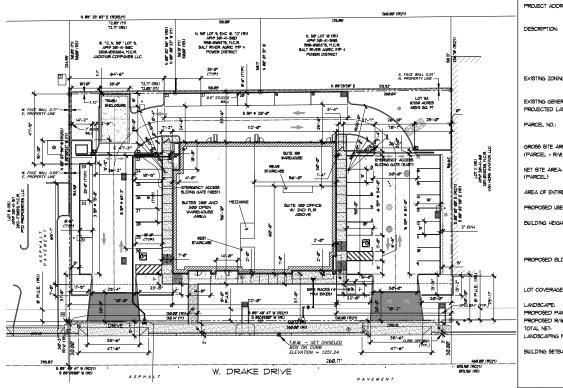



#### REFERENCE DOCUMENTS

ro working days before you o CALL FOR BLUE STAKES

263-1100 Store Stoke Center CALL COLLECT

DEED 2023-0580941, M.C.R. (RI) PLAT PER BOOK 223, PAGE 38, M.C.R.

(R2) R.O.S. PER BOOK 1079, PAGE 39, M.C.R. (R3) R.O.S. PER BOOK 1503, PAGE 35, M.C.R.

NOTES

PROJECT DATA

REINBOLD DEVELOPMENT, LLC PROJECT NAME:

PROJECT ADDRESS: 1540 W. DRAKE DRIVE

TEMPE, AZ. 85283

DESCRIPTION: SCOPE OF WORK IS TO PROVIDE SITE PLANNING

SERVICES AND NEW BUILDING DESIGN FOR VACANT PARCEL APPROXIMATELY 0.93 ACRES. THIS PARCEL WILL BE FOR THE DEVELOPMENT OF A NEW OFFICE WAREHOUSE BUILDING WITH FOOT PRINT OF 112' X 90' AND ADDITIONAL STORAGE

2ND FLOOR ABOVE SUITE I.

EXISTING ZONING: GID GENERAL INDUSTRIAL DISTRICT

AND SOUTHWEST OVERLAY DISTRICT (SWOD)

EXISTING GENERAL PLAN

PROJECTED LAND USE: INDUSTRIAL

301-41-1594 4 301-41-1584 PARCEL NO: (COMBINED PARCEL PENDING)

GROSS SITE AREA: 48,323 S.F. - LII ACRES (PARCEL + R/W)

(PARCEL)

AREA OF ENTIRE BUILDING: SEE BUILDING AREA MATRIX

PROPOSED USES: OFFICE AND WAREHOUSE

BUILDING HEIGHT. 90 FT (65' ALLOWED IN GID + 25 IN 9WOD) ALLOWED FROM ADJ T.O.C. (TOP OF CROWN @

40,513 S.F. - 0.93 ACRES

1252 3279 MAX HEIGHT ALLOWED = 90'-0" / 1342.321'

70'-0"

PROPOSED BLDG HEIGHT: F.F. WILL BE PROPOSED TO BE AT 1253,00° 29'-8" ABOVE ADJ. T.O.C. (TOP OF ADJ ROAD

CROWN) 1281.99T

LOT COVERAGE: NO STANDARD

I ANDSCAPE: SEE LANDSCAPING PLAN PROPOSED PARCEL NET : SEE LANDSCAPING PLAN PROPOSED R/W NET = SEE LANDSCAPING PLAN SEE LANDSCAPING PLAN TOTAL NET:

LANDSCAPING PROVIDED = SEE LANDSCAPING PLAN

BUILDING SETBACKS: REQUIRED: PROVIDED SOUTH EPONT 25 FT 31-8" NORTH PEAR & ET 33'-6" EAST SIDE Ø ET 78'-1'

WEST SIDE Ø FT

PARKING CALCS

PARKING REQUIRED: (ALL PARKING CALCS ARE BASED ON "NET" S.F.) SUITE 100 OFFICE

3,144/300 = 10.48

TOTAL : 10.48 PARKING SPACES

SUITE 100

2ND FLOOR (STORAGE) SUITES 200 4 300 WAREHOUSE

3,203/500 = 6.406 4,506/500 = 9.01

SUITE 100 WAREHOUSE 1,644/500 = 3.28 TOTAL SPACES REQ'D:

10.48 + 6.406 + 9.01 + 3.28 = 29.176

29.176 = 29 PARKING SPACES (2 ACCESSIBLE=1/25)

PARKING PROVIDED: 33 PARKING SPACES (2 ACCESSIBLE)

BIKE PARKING:REQUIRED OFFICE (IST # 2ND) 1/10,000 OR 2 MINIMUM: 2 WAREHOUSE 1/10/000 OR 2 MINIMUM: 2

TOTAL BIKE SPACES REO'D: 4

BIKE PARKING PROVIDED: 4 (2 BIKE RACKS @ 2 BIKES PER RACK)

GOVERNING AGENCY: CITY OF TEMPE

BUILDING CODES: 2018 IBC, 2018 IPC, 2018 IMC, 2011 NEC, 2018

IFC, 2018 IECC, ADA. INCLUDE ALL CITY OF

TEMPE AMENDMENTS

CONSTRUCTION TYPE: VB

FIRE SPRINKLER: BUILDING WILL BE EQUIPPED WITH AN

AUTOMATIC EXTINGUISHING SYSTEM, PER CITY OF TEMPE, IBC. DEFERRED SUBMITTAL.

OCCUPANCY: BUSINESS / STORAGE


LEGAL DESCRIPTION: A REPLAT TO COMBINE LOTS 9 AND 10, "I INCOLN-FILLIOT" / I-IØ BOOK 223 OF MARS PAGE 38 MARICORA COUNTY RECORDS, LOCATED IN THE SOUTHEAST QUARTER OF SECTION 8. TOWNSHIP I SOUTH, RANGE 4 EAST OF THE GILA AND SALT RIVER BASE AND MERIDIAN, MARICOPA COUNTY, ARIZONA

AREA OF ENTIRE BUILDING: 9,948 S.F. (FOOTPRINT)

			BUILD	ING ARE	Д			
	OFF	ICE	SUITE 1000 2ND FLR. STORAGE 191		19T FLOOR WAREHOUSE STORAGE		GROSS TOTALS	NET TOTALS
OCCUP: B (BUSINESS)			5 (STORAGE)		S (STORAGE)			
	GR066 6F	NET SF	GR099 9F	NET SF	GR099 9F	NET SF		
SUITE 100	* 3,218 SF	3,144 SF	* 3,429 SF	3,065 SF	1,729 SF	1,644 SF	8,376 SF	7,853 SF
SUITE 200 4 300 (WHOLE)			149 SF	138 SF	4,675 SF	4,506 SF	4,824 SF	4,644 SF
SES/FIRE					87 SF		87 SF	
TOTALS	3,218 SF	3,144 SF	3,578 9F	3,2Ø3 ᢒ투	6,491 SF	6,150 SF	13,287 SF	12,497 5
BUILDING FOOTPRI	NT						9,94	8 SF

· INCLUDES 1/2 OF BOTH STAIRCASES

CITY OF TEMPE APPROVAL:

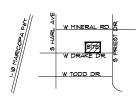

VICINITY MAP

PLANNING Ltd

Associates . Leibsohn ì 1916 NORTH Eric

DIMENSIONS BUILDING DATA ¥ ₩ PROJECT LECTRICA DRAKE DRIV , AZ 85283 럾 ଳ <u>ଡ</u>ੈ ፫ SITE <u>₹</u>₩

DATE 196UED: #3/31/2#24

CHECKED BY: ELA

SHEET NUMBER

Д-Ø.


2 OF 24



COPYRIGHT . 2024 ELA



SEE SHEET A-0.2 FORTISATEN PALGANIT 7

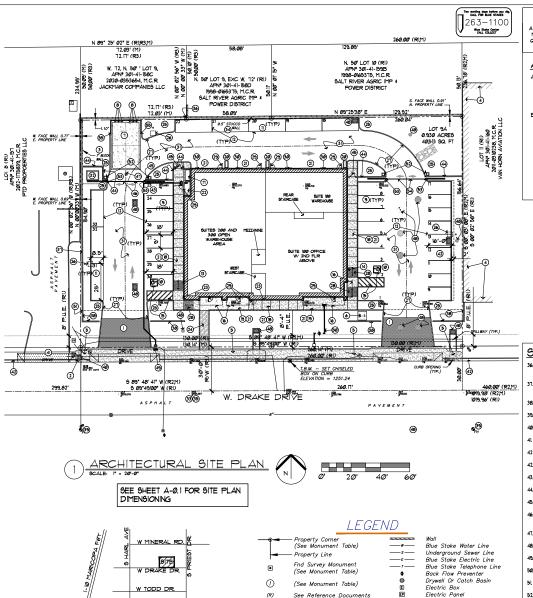

Measured

Fence

Schedule "B" Item

6 inch Concrete Curb

24 inch Vertical Curb & Gutter

Indicates Driveway (means of access) Concrete Surface

•

N DELINE N

VICINITY MAP

#### LEGAL DESCRIPTION

A REPLAT TO COMBINE LOTS 9 AND 10, "LINCOLN-ELLIOT" / 1-10, BOOK 223 OF MAPS, PAGE 38, MARICOPA COUNTY RECORDS, LOCATED IN THE SOUTHEAST QUARTER OF SECTION 8. TOWNSHIP I SOUTH RANGE 4 EAST OF THE GILA AND SALT RIVER BASE AND MERIDIAN, MARICOPA COUNTY, ARIZONA

#### ADDITIONAL SITE PLAN NOTES:

- A. PAVING AT EACH DRIVEWAY CONSISTING OF INTEGRAL COLORED UNIT PAYING. EXTEND THIS PAYING IN THE DRIVEWAY FROM THE RIGHT-OF-WAY (R/W) I INF TO 20'-0" ON SITE AND FROM CURB AT DRIVE EDGES. FROM SIDEWALK TO R/W LINE, EXTEND CONCRETE PAVING TO MATCH SIDEWALK
- B. STRUCTURES AND FOOTINGS ARE NOT PERMITTED WITHIN PUBLIC UTILITIES EASEMENTS. HOWEVER, GATES OR REMOVABLE PANELS MAY BE USED ACROSS EASEMENTS.

SEE ALSO LANDSCAPING PLANS AND CIVIL PLANS. SEE PHOTOMETRIC PLAN FOR ALL PARCEL/BUILDING LIGHTING

#### REFERENCE DOCUMENTS

- (R) DEED 2023-0580941, M.C.R (RI) PLAT PER BOOK 223, PAGE 38, M.C.R.
- R.O.S. PER BOOK 1079, PAGE 39, M.C.R. (R3) R.O.S. PER BOOK 1503, PAGE 35, M.C.R

# SITE INFORMATION

ADDRESS: |540 4 1650 WEST DRAKE DRIVE TEMPE, ARIZONA

#### OWNERSHIP:

A.P.N.: 301-41-158A & 301-41-159A OWNER: REINBOLD DEVELOPMENT LLC. AN ARIZONA LIMITED LIABILITY COMPANY DEED: 2023-0580947, M.C.R.

#### SITE PLAN KEYNOTES (CONT):

- 36. GAP IN EXISTING MASONRY WALL TO BE COMPLETED BLOCKED IN WITH MASONRY BLOCK. TO MATCH HEIGHT, COLOR AND FINISH MATERIAL
- 37. NEW 1'-0" HIGH MASONRY PRIVACY WALL (MATCH EXISTING WALL HEIGHT, COLOR, AND FINISH MATERIAL)
- 38. NEW LOW WALL 3'-4" HEIGHT (FOR PARKING SCREENING). SEE DETAIL 1/A-0.8
- 39. EXISTING FIRE HYDRANT
- 40. EXISTING ELECTRICAL BOX TO BE RELOCATED
- 41. EXISTING ADJ. PARCEL DRIVEWAY
- 42 EXISTING 24" VERTICAL CURB 4 GUTTER
- 42 IB'-5" PACING SPACES W/ 2' OVERHANG (THIS PARKING ROW ONLY)
- 43 NOT HEED

Flectric Transforme

Telephone Manhole

TV Junction Box

Sprinkler Hook-Up (fire department)

UndergrounAttea Chimnepite 8

Public Utility Easement

Fire Hydrant

Water Meter Water Valve

P.U.E.

Sewer Manhole

Light Pole

- 44. 6' HIGH MASONRY WALL
- 45. 3' MAN GATE. SEE DETAIL 9/A-Ø.7
- 46. EMERGENCY ACCESS SLIDING GATE (WEST) (2) SINGLE ISFT SLIDING VEHICULAR GATES. SEE ELEVATIONS AND PLANS NOTES ON SHEET. A-0.5
- 41. TRASH ENCLOSURE CENTERED ON GATE WIDTH
- 48. SEE GRADING AND DRAINAGE PLAN SET
- 49. FIRE RISER WATER SUPPLY LINE
- 50. WATER LINE SERVICE TO BUILDING
- 51 MASONRY WALL HEIGHT CHANGE
- 52. VEHICULAR SLIDING GATE CONTROLLER ON A 2' X 2' CONC. PAD
- 54 EMERGENCY ACCESS SUDING GATE (EAST) (2) SINGLE BET SUDING VEHICULAR GATES. SEE ELEVATIONS AND PLANS NOTES ON SHEET A-0.6
- DIA CONC. FTG. AT REPUSE ENCLOSURE END OF WALL PROTECTION. SEE DETAIL T/AØ.T

#### SITE PLAN KEYNOTES: ()

- NEW DECORATIVE CONCRETE DRIVEWAY APRON TO BE INTEGRAL COLORED AND SCORED DIAGONAL W/ SALT FINISH ON CONC. (TYP. OF 2). SEE SITE PLAN NOTE
- 2. EXISTING CITY STREET LIGHT TO BE RELOCATED
- 3. EXISTING 1'-0" BLOCK WALL TO REMAIN
- 4. EXISTING BUILDING AT ADJ. PARCEL ALONG PARCEL BOUNDARY
- NEW CONC. SIDEWALK AND ROLLED CURB ALONG WIDRAKE DRIVE TO CONNECT WITH EXISTING CONC. SIDE WALK AND CURB ON EAST AND WEST SIDES OF PARCEL
- 6. (2) BIKE RACKS (2 BIKE SPOTS PER RACK) ON A CONC. PAD. FOR BICYCLE CALCULATIONS SEE SHEET A-0.1. SEE DETAIL 6/A-0.8
- 20' X 33'-T" CONC. TRASH CONTAINER PAD. SEE ALSO KEY NOTE 8. TRASH ENCLOSURE DOES NOT HAVE GATES. SEE DETAIL 5/AØ.1
- 8 BOLLARDS (OTY OF 8) 4" DIA SCH 48 STEEL PIPE GROUTED SOLID 4 12" DIA CONC. FTG. AT TRASH CONTAINER PAD. SEE DETAIL 1/A0.1
- 9 STANDARD 9' X 18' PARKING SPACE (QTY OF 23)
- 10. STANDARD 11' X 18' ADA PARKING SPACE (QTY OF 2)
- 11. STANDARD 8'-6" X 25' PARALLEL PARKING SPACE (QTY OF 8)
- 12. PAINT 4-INCH SOLID WHITE PARKING STRIPES TO MUNICIPALITY STANDARDS
- 3. NEW ACCESSIBLE PARKING SIGN. SEE DETAIL 4/A-0.1
- 14. NEW ACCESSIBLE PARKING SKIN W/ "VAN" PLACARD. SEE DETAIL 4/AØ.1
- B. PAINT ACCESSIBLE PARKING SYMBOLS, TEXT, AND DIAGONALS. SEE DETAIL VA-0.1
- 16. METAL CANOPY OVERHANG OUTLINE AT STORE FRONT. SEE ELEVATIONS
- 17. ELECTRICAL SWITCHGEAR (SES) ON A CONC. PAD AT NW CORNER OF BUILDING
- 18. T' WIDE CONC. SIDEWALK AT STOREFRONT W/ SALT FINISH
- IS NEW CONC. AT STOREFRONT W/ SALT FINISH
- 20. CONC. SPLASH BLOCK ON NORTH SIDE OF BUILDING ONLY (QTY OF 3). SEE DFTAIL 12/4/9 T
- 21. CONC./ASPHALT MUST SLOPE MIN. IS AWAY FROM ADJ. BUILDING
- 22. FIRE RISER ROOM (ALSO CONTAINS ROOF ACCESS HATCH PER ROOF PLAN)
- 23. ROOF DRAINAGE LAMB TONGUE DRAINS OUT ONTO SIDEWALK
- 24. ADA CONC. PATH FROM STREET TO BUILDING W/ SALT FINISH, RAISED AND STRIPED PER ADA STANDARDS
- 25. PARKING ISLAND
- 26. NEW PARKING LOT LIGHTS ON POLES, SEE PHOTOMETRIC PLAN. SEE DETAIL
- 21. 6" CONC. CURB RIBBON (TYP.)
- 28. ADA IN-LINE RAMP PER ADA STANDARDS PER DETAIL 2/AØ.T
- 29. INDICATES MAN DOOR IN BUILDING SEE ARCHITECTURAL PLAN
- 30. INDICATES INSULATED PANEL ROLL-UP WAREHOUSE DOOR SEE ARCHITECTURAL
- 31. ASPHALT PAVING
- 32. NEW TRANSFORMER (5.5' X 1.5' ON A CONCRETE PAD. W/ 3' OFFSET CLEAR DISTANCE ARCHIND)
- 33. ADJ. T.O.C. (TOP OF CROWN YACANT LAND THERE IS NO EXISTING SIDEWALK) ELEVATION @ 1252.327' (SURVEY SHOT POINT). AFFECTS BUILDING HEIGHT LIMIT
- 34. EXISTING 9.5' BLOCK WALL W/ STUCCO TO REMAIN
- 35. ADJ. TOP OF ROAD CROWN ELEVATION (BASE FOR BUILDING HEIGHT MAX)

CITY OF TEMPE APPROVAL:



.

Leibsohn

ပ္

Ē

莅 룲 ≽ ভ AL DRIVE 0Z

NOTES DRAKE 1 AZ 85 矿 <u>\_\_\_</u> ≥ m/ ଳ <u>ଡ</u> ፫ ш ₹ \( \bar{7} \bar{1} <u>o</u>

DATE 186UED: #3/31/2#2-

HECKED BY: EL4

SHEET NUMBER

3 OF 24



COPYRIGHT . 2024 IIL



53. CONC. RIBBON CURB STOPS AT SLIDING GATE TRACK

55 BOLLARDS (OTY OF 2) - 6" DIA SCH 46 STEEL PIPE GROUTED SOLID 4 12"

#### PLANT LEGEND

	TREES	SIZE/ SPECIFICATION	QTY
	Pistacia chinensis "Red Push" PIstache	2.0" Cal. 10"H x 7"W Double Stake	5
( ·	Quercus virginiana Southern Live Oak	2.5" Cal. 12'H x 7'W Double Stake	2
)	Fraxinus Hybrid Fan West Ash	1.5" Cal. 7'H x 6'W Double Stake	3
$^{\prime}(^{\prime})$	Dalbergia sissoo Sissoo Tree	1.5" Cal. 9'H x 4'W Double Stake	12
	SHRUBS	SIZE	QTY
Ø	Tecoma hybrid Orange Jubllee	5 Gallon	34
$\otimes$	Dodonea viscosa Hopseed Bush	5 Gallon	7
•	Nerium oleander Petite Pink Dwarf Oleander	5 Gallon	12
①	Tecomaria capensis Cape Honeysuckle	5 Gallon	3
<b></b>	Caesalpinia pulcherrima Red Bird of Paradise	5 Gallon	8
	3' PLANT LIST	SIZE	QTY
₩	Guara lindheimeri Whirling Butterflies	1 Gallon	6
0	Justicia spicigera Mexican Honeysuckle	1 Gallon	6
$\Theta$	Leucophyllum candidum Thunder Cloud Sage	1 Gallon	18
•	Muhlenbergia capillaris "Regal Mist" Deer Grass	1 Gallon	16
	2' PLANT LIST	SIZE	QTY
	Convolvulus cneorum Bush Moming Glory	1 Gallon	22
•	Lantana montevidensis Gold Mound Lantana	1 Gallon	33
₿	Muhlenbergia Rigens Dwarf Muhly	1 Gallon	38
	Raphiolepis indica "Ballerina" Ballerina Indian Hawthom	1 Gallon	13
	Rosemarinus officinalis "blue boy" Dwarf Rosemary	'1 Gallon	31
	LANDSCAPE MATERIALS	SIZE	QTY
	Decomposed granite	3/4" Sized	9,810 S.F.

#### LANDSCAPE CALCULATION:

"Desert Gold"

GROSS SITE AREA = 48 323 S.E. REQUIRED LANDSCAPE AREA (10%) = 4,831 S.F. PROVIDED LANDSCAPE AREA = 9,590 S.F.

#### LANDSCAPE NOTES

PLANT MATERIAL TO BE APPROVED BY THE LANDSCAPE ARCHITECT PRIOR TO INSTALLATION.

ALL TREE LOCATIONS TO BE STAKED BY THE LANDSCAPE CONTRACTOR AND APPROVED BY THE LANDSCAPE ARCHITECT PRIOR TO ANY HOLES BEING DUG.

ALL GRADES TO BE APPROVED BY THE LANDSCAPE ARCHITECT PRIOR TO THE INSTALLATION OF ANY PLANT MATERIAL.

LANDSCAPE CONTRACTOR SHALL BE RESPONSIBLE FOR PROVIDING FINISHED GRADES.

THE LANDSCAPE CONTRACTOR SHALL VERIFY BERM AND RETENTION BASIN LOCATIONS SHOWN ON THESE PLANS WITH THOSE ON THE CIVIL ENGINEERING PLANS. SHOULD A DISCREPANCY EXIST BETWEEN THE PLANS, THIS OFFICE SHALL BE NOTIFIED IMMEDIATELY

ALL PALMS AND DECIDUOUS TREES TO BE UNCONDITIONALLY GUARANTEED FOR ONE YEAR AFTER INSTALLATION.

LANDSCAPE CONTRACTOR IS RESPONSIBLE FOR PROVIDING POSITIVE DRAINAGE AWAY FROM ALL BUILDINGS DURING THE FINISH GRADING PROCESS.

ALL VALVE BOXES (IRRIGATION, GATE VALVE, FLUSH CAP, WATER FEATURE, ETC.) ARE TO BE PLACED IN DECOMPOSED GRANITES/RRUB AREAS. UNDER NO CIRCUMSTANCES ARE VALVE BOXES TO BE PLACED IN A LAWN OR HARDSCAPE AREAS.

ALL TREES IN LAWN AREAS TO RECEIVE ARBOR GUARDS.

ALL SLOPES NOT TO EXCEED 4:1 IN LANDSCAPE AREAS.

LINDER NO CIRCUMSTANCES SHALL ANY TREE BE PLANTED WITHIN 6' OF ANY BUILDING WITHOUT THE EXPRESS APPROVAL OF THE LANDSCAPE ARCHITECT.

IT IS THE REPONSIBILITY OF THE LANDSCAPE CONTRACTOR TO INFORM THE LANDSCAPE ARCHITECT/OWNER OF ANY PLANT MATERIAL CONCERNS BASED ON PLANTING SEASON (E.G. WINTER, SUMMER). SHOULD THE LANDSCAPE CONTRACTOR HAVE ANY CONCERNS ABOUT PLANT MATERIAL DUE TO HEAT. FROST OR EXPOSURE, HE SHALL REQUEST A SUBSTITUTION OR DELAY IN PLANTING. ONCE PLANTED, ALL PLANT MATERIAL IS SUBJECT TO SPECIFIED WARRANTEES.

#### IRRIGATION LEGEND

#### **EQUIPMENT**

C.O.T PER CODE 3/4" WATER METER 34 WATER METER
ELECTRIC CONTROLLER (OUTDOOR 6 STATION)
3/4" BACKFLOW PREVENTER W/ ENCLOSURE
QUICK COUPLER
BALL VALVE RAIN DIAL FEBCO RAINBIRD NIBCO 825Y-BV 33DRC/33K

#### DRIP EQUIPMENT

RAINBIRD INLINE CONTROL ZONE KIT PVC 90 ST. EL. W/THREADED CAP PVC 90 ST. EL. W/CAP PVC DRIP FLUSH END CAP PVC DRIP END CAP ► SPEARS BOWSMITH SL & ML 200 SERIES SINGLE & MULTI-PORT EMITTERS

PROVIDE (2) ML-220 EMITTERS PER TREE EQUALLY SPACED AND (1) SL-210 EMITTER PER SHRUB OR GROUNDCOVER OR (1) ML-210 PER 6 PLANTS WITH A MAXIMUM DISTRIBUTION LINE LENGTH OF 5.

#### PIPE SCHEDULE

PIPE LEGEND

---- CLASS 200 PVC (LATERALS)
---- SCH. 40 PVC (MAÎN LÎNE)
---- SCH. 40 PVC (SLEEVES)

1-1/4° 1-1/2°

2-1/2\* 3"

CHEDOLL		COI
0-5 6-10 11-18 19-27	G.P.M. G.P.M. G.P.M. G.P.M.	IRRIG WHEF REQU
28-36 37-57 58-80	G.P.M. G.P.M. G.P.M.	SCI
81-120	G.P.M.	COL

#### CONTROLLER(S)

GATION CONTROLLER(S) TO BE WALL MOUNTED RE INDICATED ON THE PLAN. COORDINATE POWER UIREMENTS WITH GENERAL CONTRACTOR

CONTROLLER: IRRITROL RAIN DIAL: 6 STATION

PROGRAM "A": (1-3) DRIP

#### IRRIGATION NOTES

THE IRRIGATION PLAN IS DIAGRAMMATIC AND IT SHALL BE THE IRRIGATION CONTRACTOR'S RESPONSIBILITY TO ADJUST THE LOCATION OF ANY HEAD TO PROVIDE FULL AND ADEQUATE COVERAGE OR TO ADD ADDITIONAL HEADS AS NECESSARY TO ENSURE 100% COVERAGE OF ALL PLANT MATERIALS.

THE IRRIGATION SYSTEM HAS BEEN DESIGNED FOR 60 PSI. THE IRRIGATION CONTRACTOR SHALL VERIFY THE WATER PRESSURE IN THE FIELD AND NOTIFY THE LANDSCAPE ARCHITECT IMMEDIATELY SHOULD A DISCREPANCY EXIST.

THE IRRIGATION CONTRACTOR SHALL SIZE THE PIPE ACCORDING TO THE PIPE SCHEDULE. GALLONS PER MINUTE ARE CALCULATED BY THE COMBINED EMISSION HEAD OUTPUT DOWNLINE FROM PIPE BEING SIZED.

IRRIGATION SLEEVES ARE TO BE SCHEDULE 40 PVC WITH A MINIMUM DIAMETER TWICE THE SIZE OF THE IRRIGATION LINE. IRRIGATION ON SLEEVES ARE TO EXTEND 12" BEYOND EDGE OF PAVEMENT, WALL OR CURB AND A MINIMUM OF 36" BEYOND EDGE OF SIDEWALKS.

CONTROLLERS ARE TO BE PROGRAMMED TO ALLOW SUFFICIENT FLOW RATES ARE MAINTAINED THROUGHOUT THE SYSTEM.

ALL VALVE BOXES (IRRIGATION, GATE VALVE, FLUSH CAP, WATER FEATURE, CONTROL WIRE, ETC.) ARE TO BE PLACED IN DECOMPOSED GRANITE/SHRUB AREAS. UNDER NO CIRCUMSTANCES ARE VALVE BOXES TO BE PLACED IN A LAWN OR HARDSCAPE AREA.

IT IS THE IRRIGATION CONTRACTORS RESPONSIBILITY TO PROVIDE FULL AND ADEQUATE COVERAGE TO ALL LANDSCAPE MATERIAL INDICATED ON THE CORRESPONDING LANDSCAPE PLAN.

Ξ d n 0 C a) ਰ .\_ ᅩ c a \_ В

biltform landscape architecture group, inc.

11460 North Cave Creek Rd. suite 11 phoenix artzona 85020 Phone 602:285.9200 Fax 602:285.9229 emall: dave@blltform.com

DING D W. DRAKE BUILD 1650 ≥ ⊗ 일빙 AL DRI ECTRICA DRAKE D AZ 85283 ⊟ਂ≽ਂ AME 1540 TEMPE

PLANNING

7

3SIQV

ਭੂ ਦਿ

2002

NORTH R 101 (P)

7970

Associates

Leibsohn

Eric

DRI

PROJECT NO.: 11792 DATE ISSUED: 12/30/2023

CHECKED BY: DF

SHEET NUMBER

CS 1.1

1 of 7



COPYRIGHT © 2024 ELA



#### CITY OF TEMPE NOTES

ALL SITE IMPROVEMENTS INCLUDING LANDSCAPING AND SITE CLEANUP, MUST BE COMPLETED PRIOR TO CERTIFICATE OF OCCUPANCY FOR ANY BUILDING WITHIN A PHASE.

ALL TREES WITHIN THE LINE OF SIGHT WILL MAINTAIN A CANOPY HEIGHT ABOVE 6', ALL SHRUBS IN THIS AREA MAY NOT REACH AT MATURITY A HIEGHT OVER 24".

ALL PLANT MATERIALS ARE GUARANTEED FOR A MINIMUM PERIOD OF SIXTY (60) DAYS FROM THE DATE OF FINAL APPROVAL BY THE CITY, ANY PLANT MATERIALS, WHICH ARE NOT APPROVED BY THE CITY PRIOR TO OCTOBER 1 OF THE CALENDAR YEAR IN WHICH THEY ARE INSTALLED. SHALL BE FURTHER GUARANTEED UNTIL MAY 20 OF THE FOLLOWING CALENDAR YEAR.

TREES, SHRUBS, VINES, GROUNDCOVERS AND TURF THAT HAVE TO BE REPLACED UNDER TERMS OF THE GUARANTEE, SHALL BE GUARANTEED FOR AN ADDITIONAL 60 DAYS FROM THE DATE OF REPLACEMENT.

ALL PLANT MATERIALS MUST BE MAINTAINED IN HEALTH AND VIGOR AND BE ALLOWED TO ATTAIN NATURAL SIZE AND SHAPE IN ACCORDANCE WITH THE ORIGINALLY APPROVED LANDSCAPE PLAN. SEE SECTION 1902 (6) (H).

PARKING LOT TREES MUST HAVE A MINIMUM CLEAR CANODY

FINISH GRADE OF LANDSCAPE AREAS (TOP OF TURF OR D.G.) MUST BE GRADED TO 1 1/2" BELOW CONCRETE OR OTHER PAYED SURFACES. SEE SECTION 1903 (6) (C) ZONING CODE.


TREES MUST BE PLACED A MINIMUM OF 5' FROM SIDEWALKS, PUBLIC ACCESS WAYS. SHRUBS MUST BE, AT MATURITY, 3' FROM ALL SIDES OF A FIRE HYDRANT. SEE SECTION 1902 (6) (11), ZONING CODE.

ALL LANDSCAPING SHALL BE MAINTAINED BY THE LANDOWNER OR THE LESSOR. SEE SECTION 1903 (6) (G) ZONING CODE. THERE SHALL BE NO OBSTRUCTION OF SITE SIGNAGE BY

LANDSCAPE PLANT MATERIAL, AND THAT SUCH MUST BE RELOCATED/ CORRECTED BEFORE THE FIELD INSPECTION WILL ACCEPT/ PASS THE SIGN IN THE FIELD OR ISSUE A CERTIFICATE OF OCCUPANCY FOR A PROJECT.

ALL TREES SHALL COMPLY WITH THE LATEST AMENDED EDITION OF THE "ARIZONA NURSERY ASSOCIATION- RECOMMENDED TREE SPECIFICATIONS" SEE SECTION 1903 (6) (A) ZONING CODE

SIGNS REQUIRE A SEPARATE PERMIT

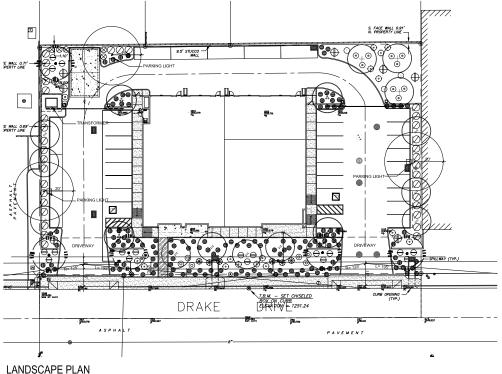

#### PLANT LEGEND

-ttr-	TREES	SIZE/ SPECIFICATION	QTY
•	Pistacia chinensis "Red Push" Pistache	2.0* Cal. 10'H x 7'W Double Stake	5
an A	Quercus virginiana Southern Live Oak	2.5" Cal. 12'H x 7'W Double Stake	4
(+)	Fraxinus Hybrid Fan West Ash	1.5" Cal. 7"H x 6"W Double Stake	3
	Dalbergia sissoo Sissoo Tree	1.5" Cal. 9'H x 4'W Double Stake	10
	SHRUBS	SIZE	QTY
Ø	Tecoma hybrid Orange Jubliee	5 Gallon	35
$\otimes$	Dodonea viscosa Hopseed Bush	5 Gallon	5
•	Nerium oleander Petite Pink Dwarf Oleander	5 Gallon	11
0	Tecomaria capensis Cape Honeysuckle	5 Gallon	3
<b>⊕</b>	Caesalpinia pulcherrima Red Blrd of Paradise	5 Gallon	8
	3' PLANT LIST	SIZE	QTY
₩	Guara lindheimeri Whirling Butterfiles	1 Gallon	6
0	Justicia spicigera Mexican Honeysuckle	1 Gallon	6
$\Theta$	Leucophyllum candidum Thunder Cloud Sage	1 Gallon	18
•	Muhlenbergia capillaris "Regal Mlst" Deer Grass	1 Gallon	16
	2' PLANT LIST	SIZE	QTY
	Convolvulus cneorum Bush Morning Glory	1 Gallon	22
•	Lantana montevidensis Gold Mound Lantana	1 Gallon	40
₿	Muhlenbergia Rigens Dwarf Muhly	1 Gallon	38
•	Raphiolepis indica "Ballerina" Ballerina Indian Hawthorn	1 Gallon	13
0	Rosemarinus officinalis "blue boy" Dwarf Rosemary	1 Gallon	31
	LANDSCAPE MATERIALS	SIZE	QTY
	Decomposed granite "Desert Gold"	3/4" Sized 2" Depth	9,595 S.F.

	TREES	SIZE/ SPECIFICATION	QTY
	Pistacia chinensis "Red Push" Pistache	2.0° Cal. 10'H x 7'W Double Stake	5
h ( ^	Quercus virginiana Southern Live Oak	2.5" Cal. 12'H x 7'W Double Stake	4
+)	Fraxinus Hybrid Fan West Ash	1.5" Cal. 7'H x 6'W Double Stake	3
<b>-</b> (*)	Dalbergia sissoo Slssoo Tree	1.5" Cal, 9'H x 4"W Double Stake	10
	SHRUBS	SIZE	QTY
Ø	Tecoma hybrid Orange Jubliee	5 Gallon	35
$\otimes$	Dodonea viscosa Hopseed Bush	5 Gallon	5
•	Nerium oleander Petite Pink Dwarf Oleander	5 Gallon	11
①	Tecomaria capensis Cape Honeysuckle	5 Gallon	3
<b>⊕</b>	Caesalpinia pulcherrima Red Blrd of Paradise	5 Gallon	8
	3' PLANT LIST	SIZE	QTY
₩	Guara lindheimeri Whiring Butterfiles	1 Gallon	6
0	Justicia spicigera Mexican Honeysuckle	1 Gallon	6
$\ominus$	Leucophyllum candidum Thunder Cloud Sage	1 Gallon	18
•	Muhlenbergia capillaris "Regal Mist" Deer Grass	1 Gallon	16
	2' PLANT L <b>I</b> ST	SIZE	QTY
	Convolvulus cneorum Bush Morning Glory	1 Gallon	22
•	Lantana montevidensis Gold Mound Lantana	1 Gallon	40
₿	Muhlenbergia Rigens Dwarf Muhly	1 Gallon	38
	Raphiolepis indica "Ballerina" Ballerina Indian Hawthorn	1 Gallon	13
0	Rosemarinus officinalis "blue boy Dwarf Rosemary	"1 Gallon	31
	LANDSCAPE MATERIALS	SIZE	QTY

#### LANDSCAPE CALCULATION:

GROSS SITE AREA = 48.323 S.F. REQUIRED LANDSCAPE AREA (10%) = 4,831 S.F. PROVIDED LANDSCAPE AREA = 9,595 S.F. p e u r е ᅩ С - -

biltform landscape architecture group,

ľШ

0

11460 North Cave Creek Rd. suite 11 phoents artone 85020 Phone 802.285.9200 Fax 602.285.9229 email: dave@biltform.com

7970 NORTH RDGEVIEW DRIVE & PARADISE 480.483.1101 (P) & 480.483.1103 (F) & Eric Leibsohn

DRIVE

BUILDING 1650 W. DRAKE [ AME ELECTRICAL NEW B 1540 W. DRAKE DRIVE & 1 TEMPE, AZ 85283

DATE ISSUED: 12/30/2023


SHEET NUMBER

2 OF 7





1"= 20'- 0"

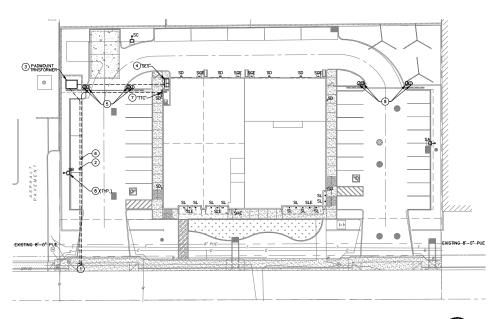

**ELECTRICAL SITE PLAN** SCALE: 1" = 20'-0"



#### **KEYED NOTES**

- POINT OF POWER/COMMUNICATION SERVICES, COORDINATE WITH UTILITY COMPANIES.
- PROVIDE PRIMARY POWER FEEDER CIRCUIT IN ACCORDANCE WITH THE POWER COMPANY (SRP) REQUIREMENTS.
- 3 PROPOSED SRP OIL-FILLED PADMOUNT TRANSFORMER. PROVIDE EQUIPMENT PAD IN ACCORDANCE WITH UTILITY COMPANY REQUIREMENTS.
- 4 BUILDING SERVICE ENTRANCE SECTION, COORDINATE WITH SRP FOR INCOMING POWER SERVICE REQUIREMENTS.
- (5) FOR MOTORIZED GATE OPERATORS (1/2HP, 120V), PROVIDE 20A, 120V POWER CIRCUITS, FEED EACH WITH 2 #10, 1 #10G, 3/4\*C. PROVIDE REQUIRED CONTROL WIRING IN 3/4\* CONDUIT TO IDF CLOSET.
- (6) FOR COMMUNICATION SYSTEM, PROVIDE (2) 4"E.C WITH INNER DUCTS.
- 7 PROVIDE EXTERIOR RATED TELEPHONE TERMINAL CABINET.
- 8 PROVIDE SITE POLE COMPLETE WITH RAISED CONCRETE BASE.

#### SHEET NOTES

- CONTRACTOR TO INSTALL ALL UTILITY RELATED RACEWAYS, TRANSFORMER PADS, ETC. SERVICES IN ACCORDANCE WITH THEIR CONSTRUCTION DRAWINGS STANDARDS.
- THE UNDERGROUND RACEWAYS SHOWN TO BE INSTALLED (MINIMUM 24" BURIAL DEPTH) PROVIDE REQUIRED NEW POWER CONDUCTORS IN NEW UNDERGROUND CONDUIT. CONTRACTOR MAY REUSE EXISTING RACEWAY.
- 3. PROVIDE BLUE STAKE SERVICES TO LOCATE PUBLIC UTILITIES.
- 4. PROVIDE OUTDOOR RATED ENCLOSURES OR WEATHERPROOF COVERS FOR EQUIPMENT OR DEVICES LOCATED OUTDOORS.

DRAWING IS PROVIDED FOR CITY PRE-APPLICATION AND SHOWS PROPOSED SITE LIGHTING AND PHOTOMETRICS. THIS DRAWING IS NOT TO BE USED FOR PRICING OR CONSTRUCTION AND DOES NOT INCLUDE DETAILS ON CREQUITING, CONTROLS, OR FINAL FIXTURE SPECIFICATIONS.



Ltd. Associates Leibsohn Eric


DING N⊞V

ELECTRICAL N. DRAKE DRIVE PE, AZ 85283 ELECTRICAL SITE PLAN AME 1540 v TEMPE

PROJECT NO.: 1823 DATE 188UED: #9/04/2024

SHEET NUMBER



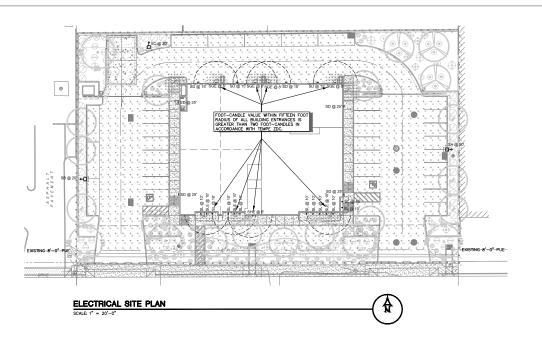

Schedule										
Symbol	Label	Quartity	Manufacturer	Catalog Number	Description	Lamp	Florano	Lumens Per Lamp	Light Loss Factor	Widtige
Ö	SA	1	цтноми центиче	DSX1 LED P7 40K BOCRI T2M MVOLT SPA HS (FIMSH) / SSS 17 // W/2.9 BASE	D-Series Size 1 Area Luminaire P7 Performance Package 4000K CCT 90 CRI Type 2 Medium Houseaide Snield	LED - 4000K	DSX1_LED_P7_40K_80 CRI_T2M_HS.ins	17479	0.91	10424348
-	SB	1	LITHONIA LIGHTING	DSX1 LED P7 40K 80CRI BLC4 MVOLT SPA (FIMSH) / SSS 17.5' W(2.5' (IASI)	D-Series Size 1 Area Luminaire P7 Performance Package 4000K CCT 80 CRI Type 4 Extreme Backlight Control	LED -4000K	DBX1_LED_P7_40K_80 CRI_BLC4.les	15309	0.91	184,43
	sc	1	LITHONIA LIGHTING	DSX1 LED P5 40K 80CRI LCCO MYOLT SPA (FIMSH) / SSS 17,5' W/2,5' BASE	D-Series Size 1 Area Luminaire P5 Purformance Package 4000K OCT 90 CRI Left Corner Cutoff Extreme Backlight Control	LED - 4000K	DSX1_LED_P5_40K_80 CRI_LCCO34s	11873	0,91	138,16
	SD	8	LITHONIA LIGHTING	WDGES LED P4 80CRI RFT 40K MVOLT SRM (FINISH)	WDGES LED WITH P4 - PERFORMANCE PACKAGE, 4000K, 80CRI, FORWARD THROW OPTIC	LED -4000K	WDGE3_LED_P4_TOCR LRFT_40KJes	12277	0.91	87,8914
	SGE	4	ЦТНОМИ ЦЕНТІМЕ	WDGE2 LED P3 40K 80CR TFTM MVOLT SRM E10WH (FINISH)	WDGE2 LED WITH P3 - PERFORMANCE PACKAGE, 4010K, 80CHI, TYPE FORWARD THROW MEDIUM OPTIC WIEM BATTERY PACK	LED -4000K	WDGEZ_LED_P3_40K_ 80CRL_TFTM.les	3106	0,91	32,1375
	SHE	1	цтноми центич	WDGEZ LED P3 40K 80CR J T3M MVOLT SRM E10WH (FINISH)	WOGEZ LED WITH P3 - PERFORMANCE PACKAGE, 4000K, 80CRI, TYPE 3 MEDIUM OPTIC WEM BATTERY PACK	LED - 4000K	WDGE2_LED_P3_40K_ 80CRL_T3M3es	3216	0,91	32,1375
0	SL	10	ALW	CRM4/WL 13 83 40 80 NN R V10 S (FINEH)	CORE WET LOCATION SURFACE MOUNT WEM BATTERY PACK	LED -4000K	CORE WL-3_4_6- DIRECT-83CRF1300(m- -80dag-NN.les	1311	0.91	11.7
0	SLE	3	ALW	CRM4/WL 13 83 40 80 NN R V10 S (FINISH) EWB	CORE WET LOCATION SURFACE MOUNT WIEW BATTERY PACK	LED -4000K	CORE WL-3_4_6- DIRECT-83CRI-1300Im- -80deg-NN-les	1311	0,91	11,7

Statistics	_		_			_
Description	Symbol	Avg	Max	Min	MooMin	AvgMin
BIKE PARKING	+	2,3 fc	2,3 fc	2,210	1,0:1	1,9:1
door!	+	16.4 fc	21.4 fc	11.0 fc	1.9.1	1,5:1
door2	+	18,2 %	23,5 %	13.5 fc	1,7:1	1,3:1
door3	+	16,610	23,150	8.7 %	2.7:1	1,9:1
door4	+	16,610	18,210	13,7 fo	1,3:1	1,2:1
door5	+	17,7 to	19,5 to	14,1 fc	1,4:1	1,3:1
door6	+	18,0 fc	19.9 fc	14.9 fc	1.3:1	1,2:1
door7	+	12,3 %	15,3 %	9.0 %	1,7:1	1,4:1
gale1	+	6,2 fo	9,4 fo	3,116	3,0.1	2,0:1
Seleo	+	4,1 fc	9,0 fc	2,610	3,5:1	1,6:1
PROPERTY LINE - FC (\$ 6" AFG	×	0.4 fc	0.6 fc	0.0 fc	NA	N/A
SITE - FC @ GRADE	+	4.5 fc	19,4 %	0.0 %	N/A	N/A
TRASH ENCLOSURE	- X	6.7 fc	6,8 fc	6,5 to	1,0:1	1,0:1



Eric Leibsohn

NEW BUILDING AME ELECTRICAL N 1540 W. DRAKE DRIVE TEMPE, AZ 85283


ELECTRICAL PHOTOMETRY PLAN

SHEET NUMBER







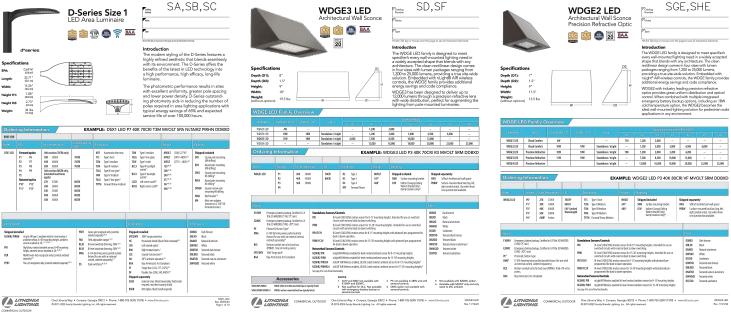




ALWUSA.COM




EXTERIOR LIGHT FIXTURES

ARCHITECTURE

Ltd.

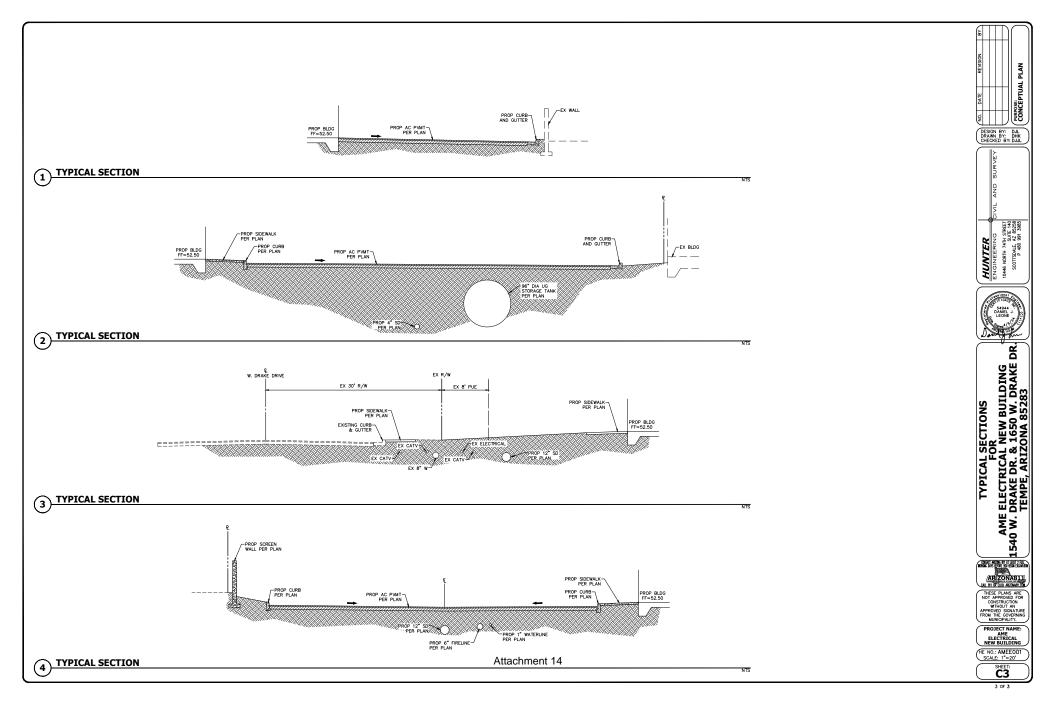

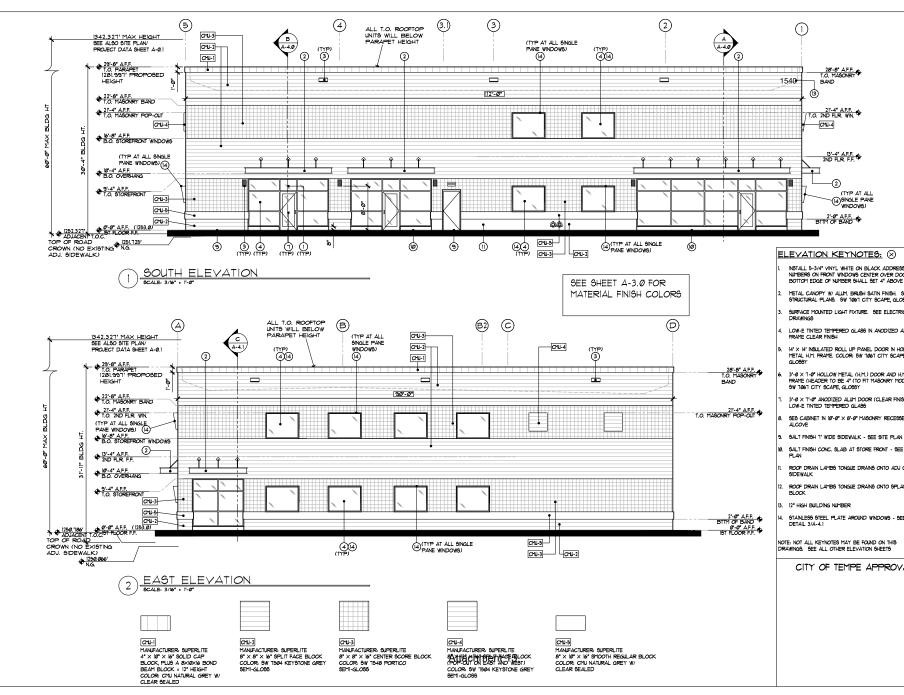

Ľť Associates . Leibsohn ì Eric

 $\overline{\Box}$ 

¥ ₩

AME ELECTRICAL N 1540 W. DRAKE DRIVE TEMPE, AZ 85283 ELEVATIONS

DATE 186UED: #3/31/2#24

CHECKED BY: ELA

SHEET NUMBER

ELEVATION KEYNOTES: (X)

INSTALL 5-3/4" VINYL WHITE ON BLACK ADDRESS NUMBERS ON FRONT WINDOWS CENTER OVER DOOR BOTTOM EDGE OF NUMBER SHALL SET 4" ABOVE FRAME.

METAL CANOPY W/ ALUM, BRUSH SATIN FINISH, SEE STRUCTURAL PLANS. SW 1061 CITY SCAPE, GLOSSY

SURFACE MOUNTED LIGHT FIXTURE. SEE ELECTRICAL

LOW-E TINTED TEMPERED GLASS IN ANODIZED ALUM.

14' X 14' INSULATED ROLL UP PANEL DOOR IN HOLLOW METAL H.M. FRAME. COLOR: 9W 1061 CITY SCAPE,

 $3^{\circ}$ -0 imes 1-0 $^{\circ}$  Hollow metal (H.M.) door and H.M. Frame (Header to be  $4^{\circ}$  (to fit masonry module). SW 1061 CITY SCAPE, GLOSSY

3'-Ø X 1'-Ø" ANODIZED ALUM DOOR (CLEAR FINISH) W/

SES CABINET IN 101-01" Y 81-01" MASONRY RECESSED

SALT FINISH CONC. SLAB AT STORE FRONT - SEE SITE

ROOF DRAIN LAMBS TONGUE DRAINS ONTO ADJ CONC.

ROOF DRAIN LAMBS TONGUE DRAINS ONTO SPLASH


STAINLESS STEEL PLATE AROUND WINDOWS - SEE


NOTE: NOT ALL KEYNOTES MAY BE FOUND ON THIS DRAWINGS. SEE ALL OTHER ELEVATION SHEETS

CITY OF TEMPE APPROVAL:

OF 24



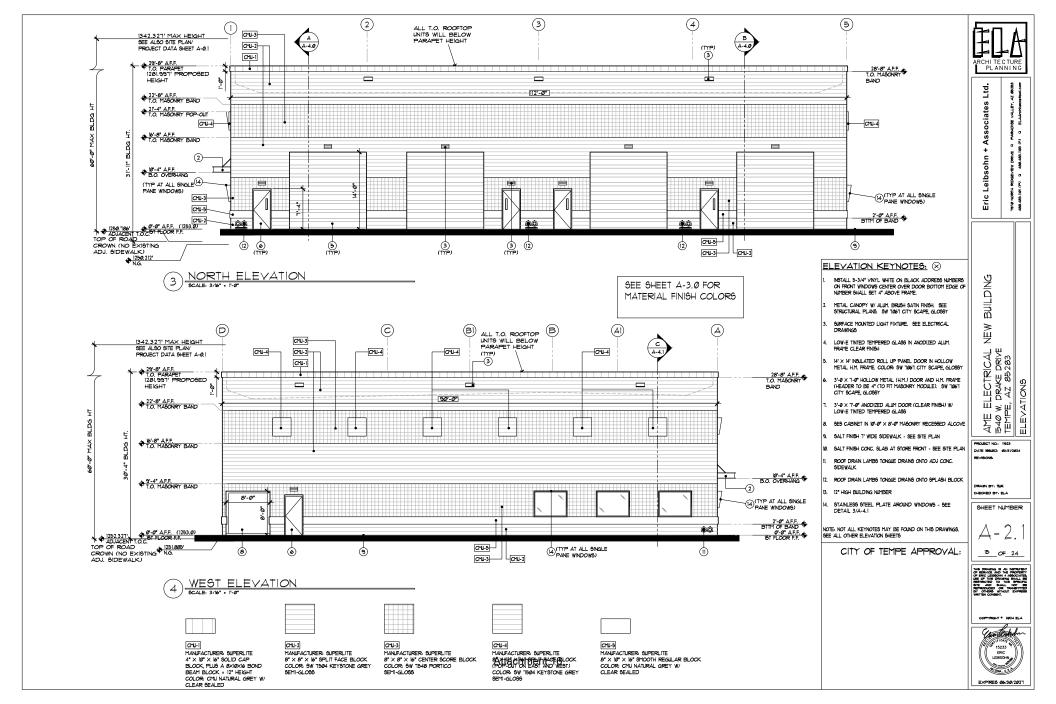

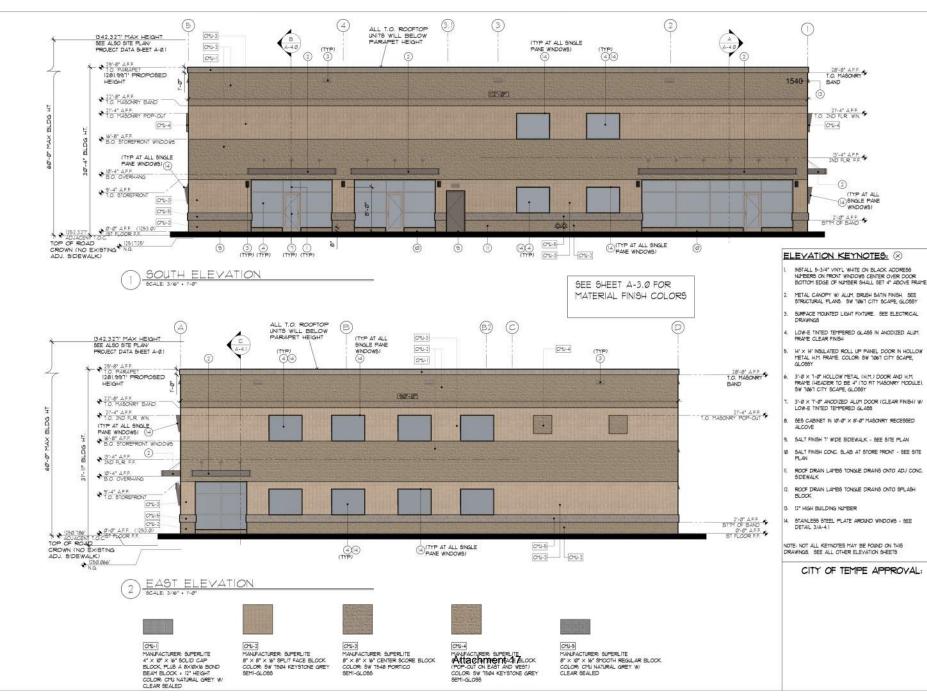

Ltd. Associates DISE VALLEY, ELAAKONISCE

Leibsohn + HER NORTH Eric

0 NH/N

AME ELECTRICAL N 1540 W. DRAKE DRIVE TEMPE, AZ 85283 ELEVATIONS

PROJECT NO. 1823 DATE 166/ED: 83/31/2824

REVISIONS:

DRAWN BY: TIK CHECKED BY: BLA


SHEET NUMBER

16 OF 24

CITY OF TEMPE APPROVAL





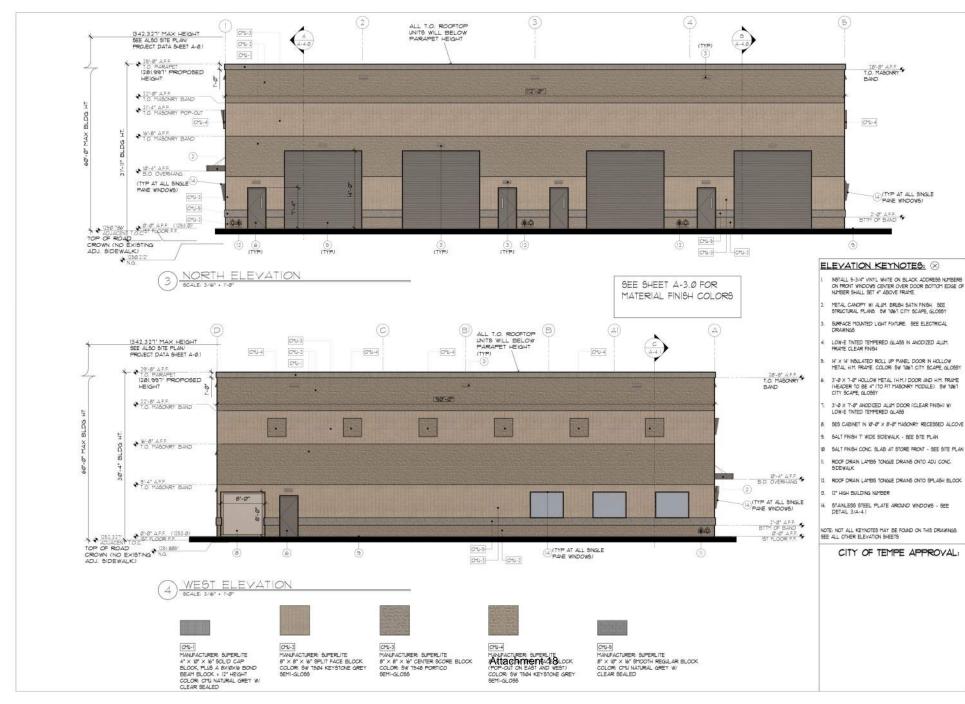

Ltd. Associates 0 0 + Leibsohn HER ABS HER C

0 × ÿ

Eric

AME ELECTRICAL N 1540 W. DRAKE DRIVE TEMPE, AZ 85283 ELEVATIONS PROJECT NO: 1825 DATE 100/ED: 05/31/2014

REVISIONS:

DRAWN BT. TLK O-ECKED BY: BLA

SHEET NUMBER

□ OF 24











CLECINICAL NEW BUILDRAKE DRIVE

AZ 85283

NDERING PERSPECTIV

OUECT NO. 1923

DRAWN BY: TLK

SHEET NUMBER

4-2.5

TO DRIVEN IS AN INTERPRET PARTICLE AND THE PROPERTY SINC LEBERON + ABOUNTS SO OF THE DRIVING GALL, BO STRICTO TO THE SPECIAL TE AND BALL, NOT BE SPECIALD ON TRANSPITTED TO THESE WINGUT EXPRESS WITE CONTROL TO THESE

COPTRONT \* 2024 No.







Eric Leibsohn

BUILDING FINISHES ≯ ₩

AME ELECTRICAL N 1540 W. DRAKE DRIVE TEMPE, AZ 85283 DIGITAL MATERIAL F

DATE 186UED: 63/31/2624

CHECKED BY: ELA

CITY OF TEMPE APPROVAL:









CMU-1

CMU-4

NEW (SUPERLITE) 4"x8"x16" SOLID CAP BLOCK (PLACE ON TOP OF A 8XIØXI6 BOND BOND BEAM) CLEAR SEALED / NATURAL GREY COLOR



CMU-2

NEW (SUPERLITE) 8"x8"x16" SPLIT FACED CMU SEMI GLOSS / COLOR: KEYSTONE GREY SHERWIN WILLIAMS 1504





CMU-3

NEW (SUPERLITE) 8"x8"x16" CENTER SCORED CMU SEMI GLOSS / COLOR: PORTICO SHERWIN WILLIAMS 1548





POP-OUT BLOCK ON EAST AND WEST SIDE OF BUILDING NEW (SUPERLITE) 8"x12"x16" SPLITFACE CMU SEMI GLOSS / COLOR: KEYSTONE GREY SHERWIN WILLIAMS 1504



NEW (SUPERLITE) 8"x10"x16" STANDARD CMU BLOCK SMOOTH SURFACE COLOR: NATURAL CMU BLOCK GREY CLEAR SEALED




LIGHT TO SG: 1.80


MANUFACTURER: GUARDIAN SUNGUARD COLOR: SUPERNEUTRAL 68 TYPE: LIGHT GRAY-SOLAR TINTED IN A CLEAR ANODIZED FRAME VIABLE LIGHT: TRANSMITTANCE: 68% REFLECT OUT: 11% REFLECT IN: 12% U-VALUE: 0.29 SHGC: 0.38




ALL MAN DOORS (DOES NOT INCLUDE STORE FRONT DOORS NOR FRAMING) 4 DOOR FRAMES, WAREHOUSE INSULATED PANEL DOORS, STEEL GATES AND REMOVABLE PANELS (PRIVACY WALLS) AND STEEL CANOPIES (ONLY) AT STORE FRONT GLOSSY / COLOR: CITY SCAPE SHERWIN WILLIAMS 1061

Attachment 21

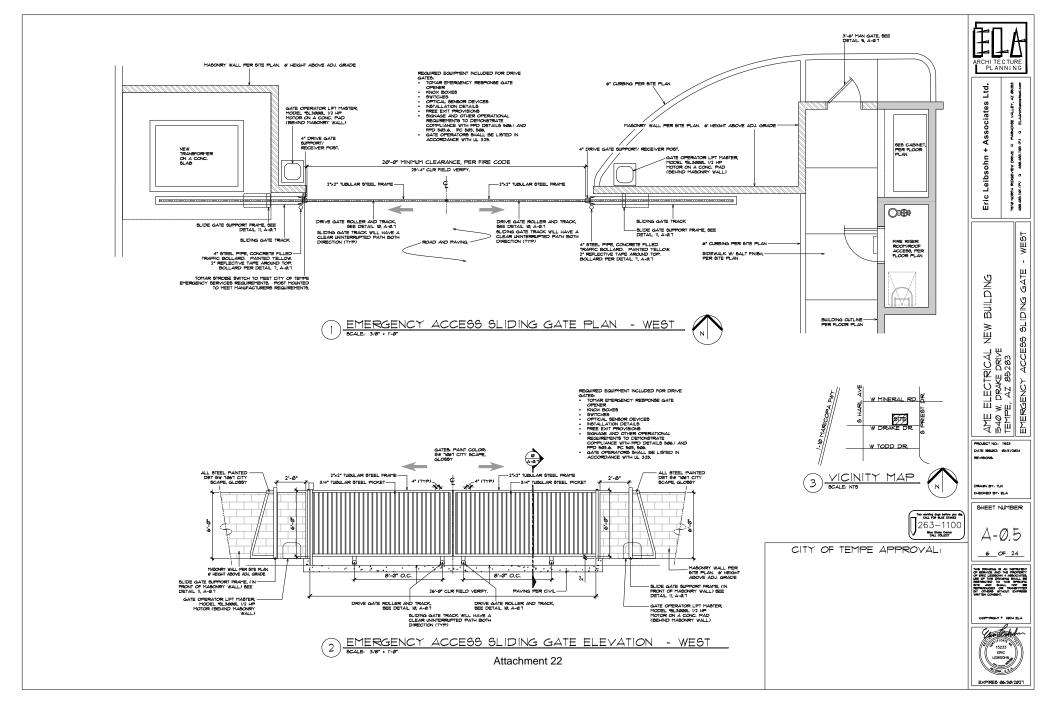

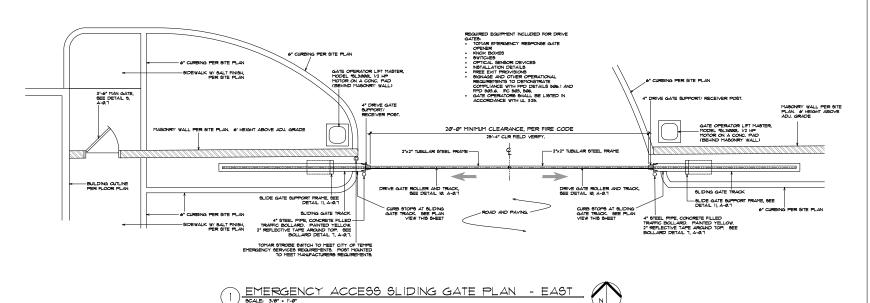

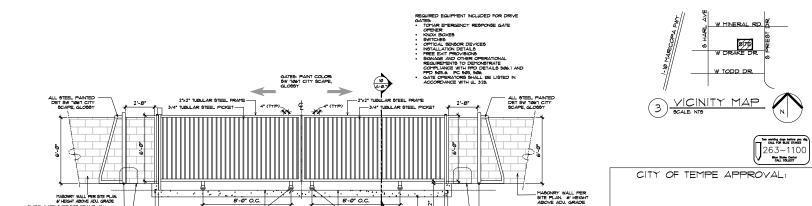

SLIDE GATE SUPPORT FRAME, (IN FRONT OF MASONRY WALL) SEE DETAIL II, A-0.7

GATE OPERATOR LIFT MASTER, MODEL 1913/00/01, 1/2 HP MOTOR ON A CONC. PAD (BEHIND MASONRY WALL)

CURB STOPS AT SLIDING GATE TRACK. SEE PLAN VIEW THIS SHEET



8'-0" O.C.

9LIDING GATE TRACK WILL HAVE A CLEAR UNITERRUPTED PATH BOTH DIRECTION (TYP)

8'-0" O.C.

CURE STOPS AT SLIDING DRIVE GATE ROLLER AND TRACK.
SEE DETAIL W, A-Q.T VIEW THIS SHEET.

MASONRY WALL PER SITE PLAN. 6' HEIGHT ABOVE ADJ. GRADE

SLIDE GATE SUPPORT FRAME, (IN-FRONT OF MASONRY WALL) SEE DETAIL II, A-Ø.T

GATE OPERATOR LIFT MASTER

MODEL \*6L3000L 1/2 HP MOTOR (BEHIND MASONRY



Ltd Associates . Leibsohn ì 1916 NORTH Eric

EA91 GATE BUILDING DING <u>8</u> × ⊒N ACCE99 AME ELECTRICAL N 1540 W. DRAKE DRIVE TEMPE, AZ 85283 EMERGENCY ACCES

DATE 186UED: #3/31/2#24

CHECKED BY: ELA


SHEET NUMBER


A-0.6


7\_OF\_24

COPYRIGHT . 2024 ELA



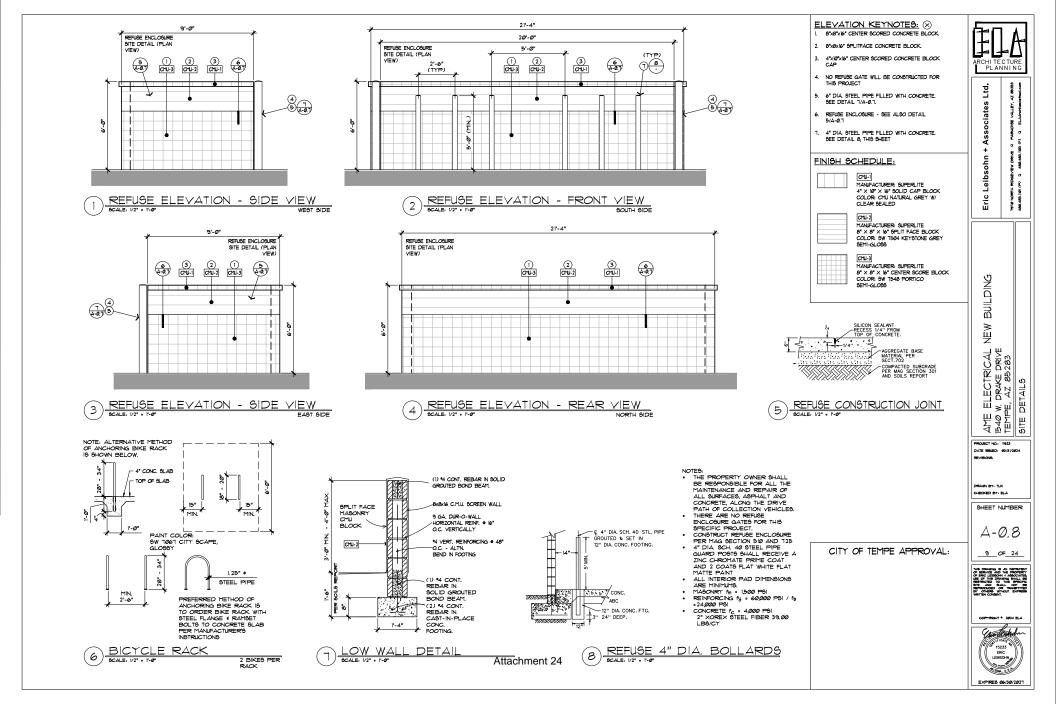

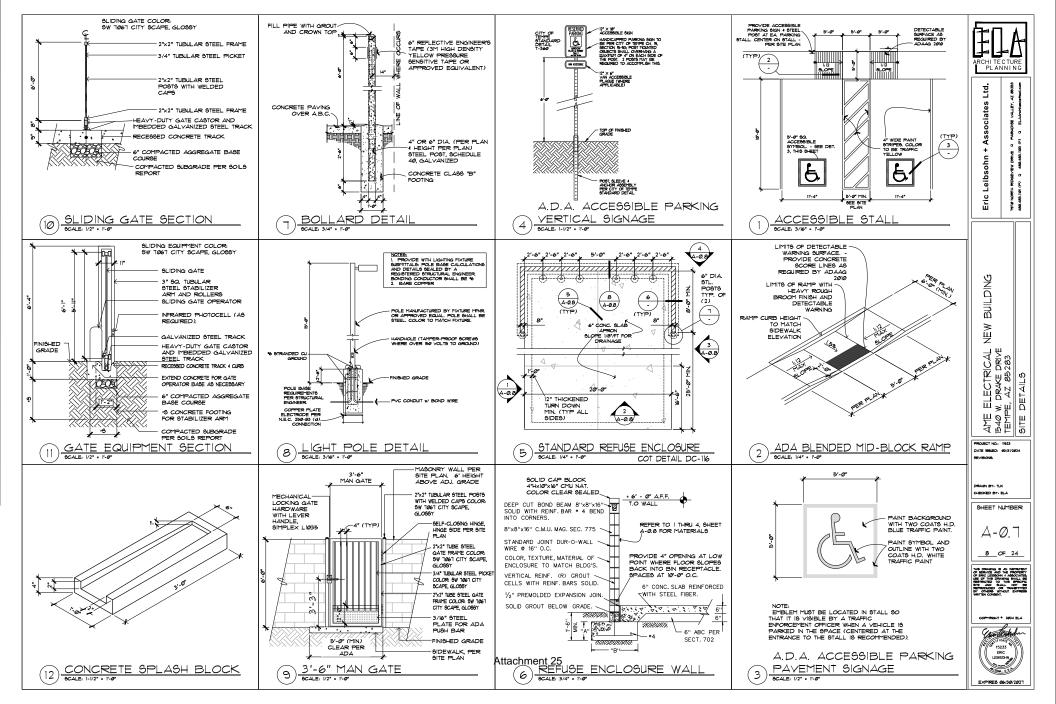

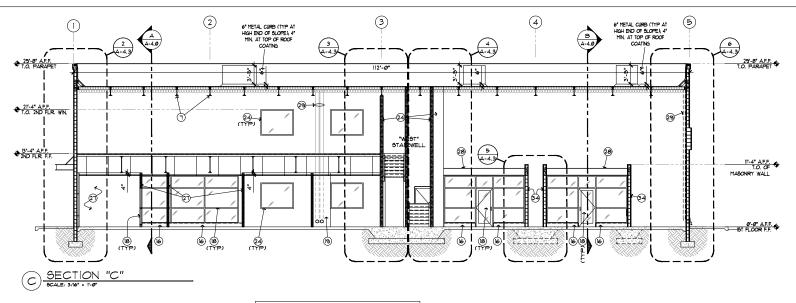

SEE SHEET A-4.2 FOR KEYED NOTE DESCRIPTIONS

ROOF OSB

DECKING

OR

TOP OF WALL DETAIL

UNDERSIDE

OF ROOF OSB

DECKING


STEEL

TRUSS

MΔIN

STUD

OR

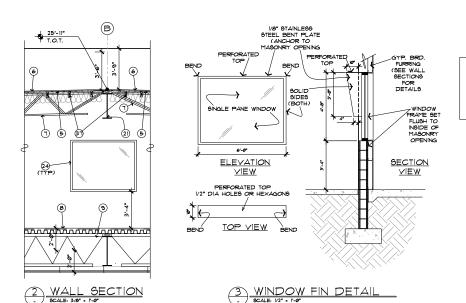

OVERALL SECTIONS ARE SHOWN FOR REFERENCE. REFER TO ENLARGED WALL SECTIONS FOR DETAIL NOTES AND ADDITIONAL INFORMATION

> REFER TO STRUCTURAL PLANS FOR ADDITIONAL INFORMATION

CITY OF TEMPE APPROVAL:

AME ELECTRICAL NEW 1540 W. DRAKE DRIVE TEMPE, AZ 85283 SECTIONS

PROJECT NO. 1923

DATE 1884ED: 63/3/2024

PLANNING

Ľť

Associates

Leibsohn

Eric

DING.

DRAWN BY: TLK CHECKED BY: ELA

SHEET NUMBER


\_\_\_\_\_OF\_\_\_24\_\_

HAS DRAWNS IS AN INSTRUMENT OF SERVICE AND THE PROPERTY OF ERIC LEIBBONN I ASSOCIATED, BE OF THIS DRAWNING HALL BE SECTION TO THIS SPECIFIC NITE AND SHALL BE SECTIONATED TO THIS SPECIFIC NITE AND SHALL BY THE AND SHALL NOT BE SECTIONATED BY CONSIST WITHOUT EXPRESS WITHOUT EXPRESS WITHTEN CONSENT.

COPYRIGHT \* 2024 ELA



Attachment 26

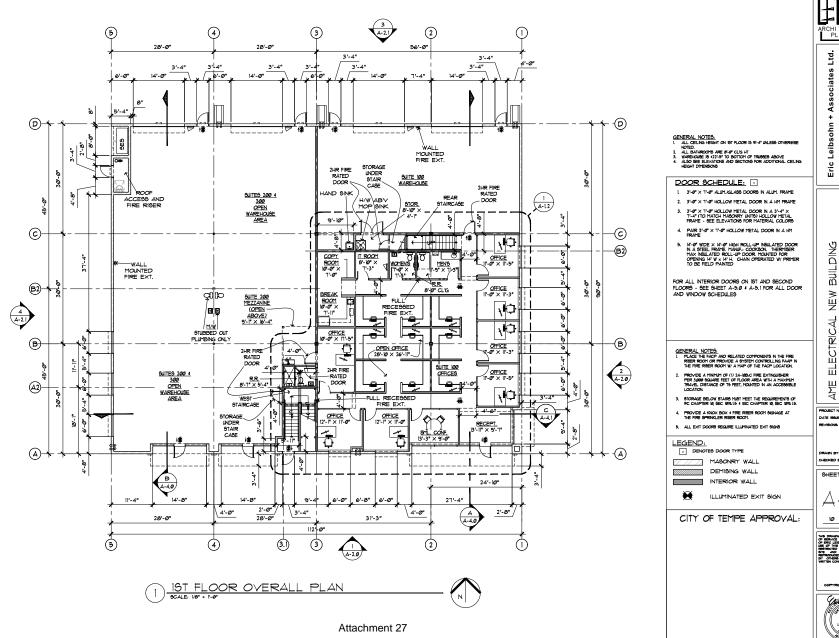

Ltd. Leibsohn · 1916 NORTH 486.483.1161 ( Eric

<u>19</u>

AME ELECTRICAL N 1540 W. DRAKE DRIVE TEMPE, AZ 85283 FLOOR PLAN OVERALL


DATE 188UED: #3/31/2#24

DRAWN BY: TLK CHECKED BY: ELA


SHEET NUMBER


Ø OF 24



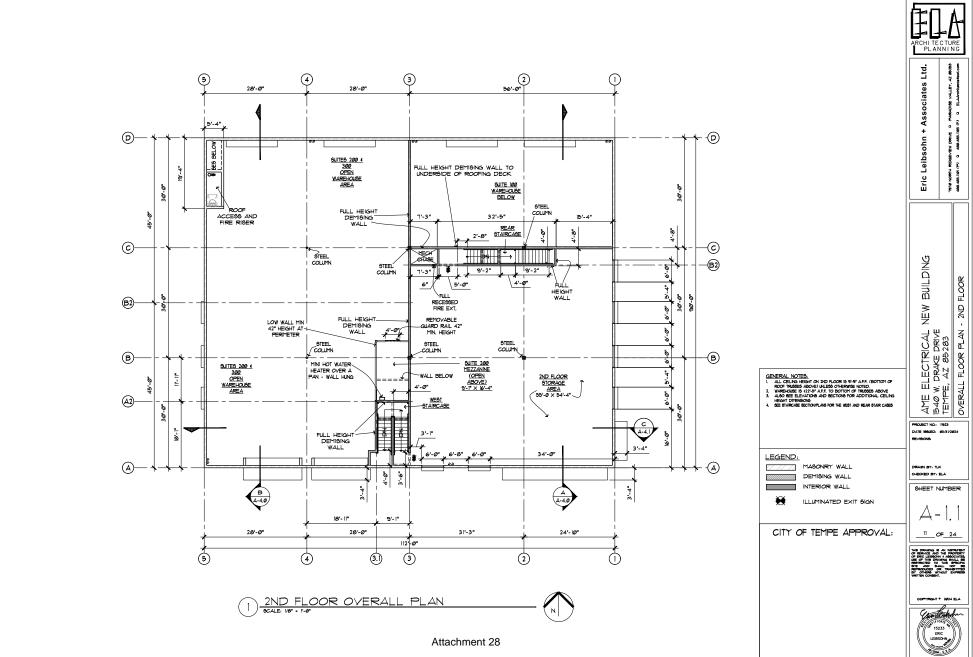

EXPIRES 06/30/2021

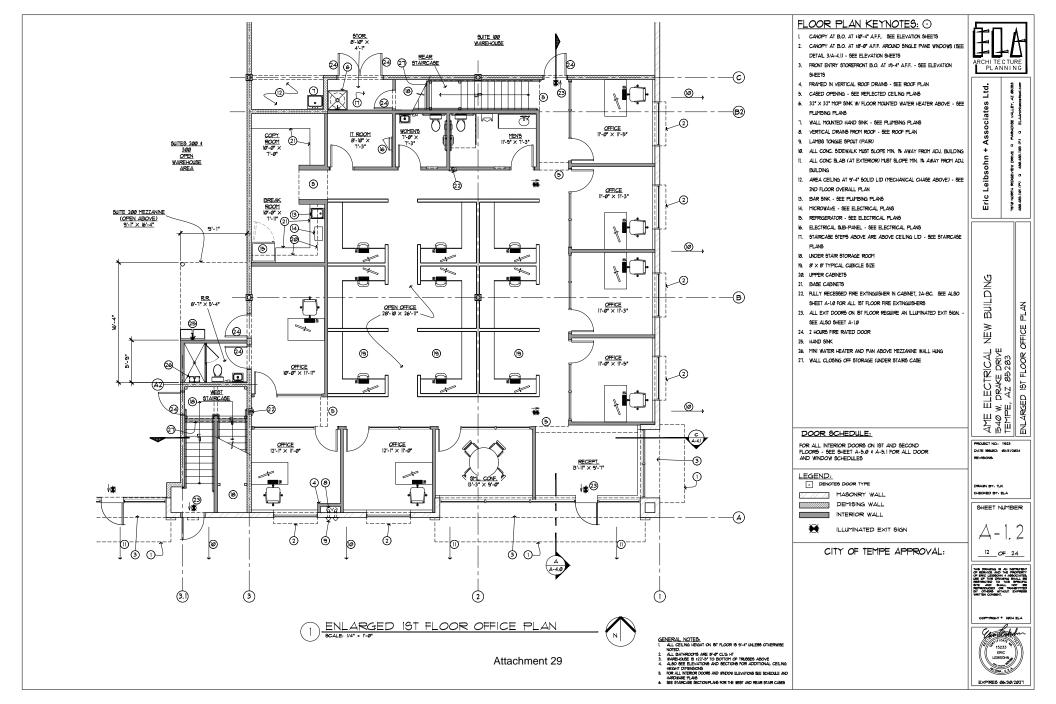

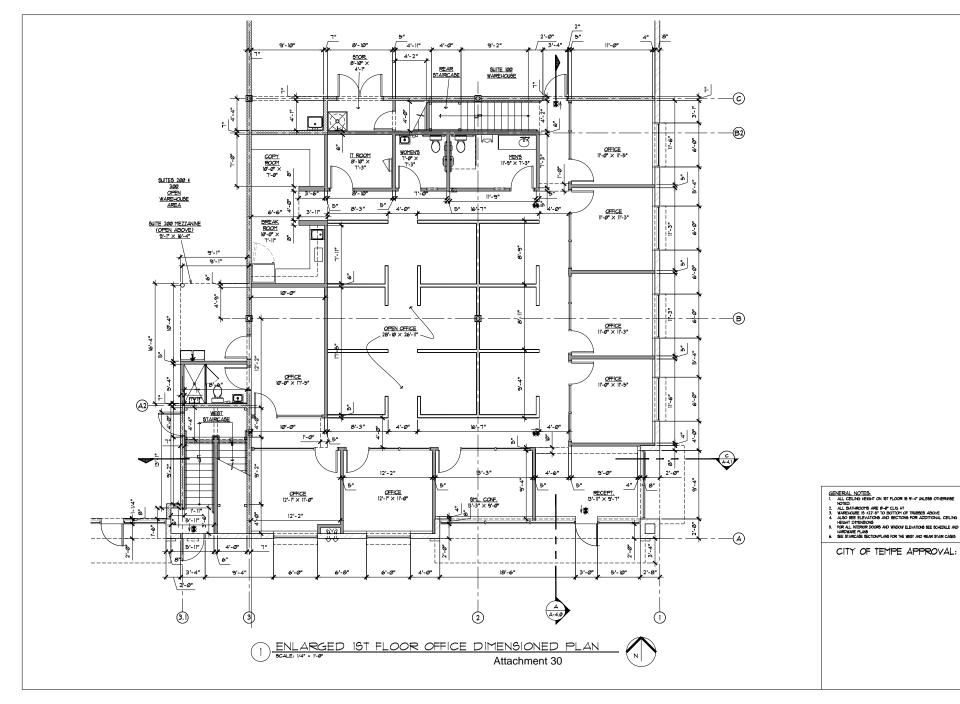

Ę Associates Leibsohn Eric

DIMENSIONED BUILDING ≯ ÿ OFFICE AME ELECTRICAL N 1540 W. DRAKE DRIVE TEMPE, AZ 85283

DATE 186UED: #3/31/2#24

CHECKED BY: ELA

SHEET NUMBER

13 OF 24

CITY OF TEMPE APPROVAL:



